


BRUNSWICK COUNTY REST AREA RENOV. US 17 AT NC 130 SHALLOTTE, NC

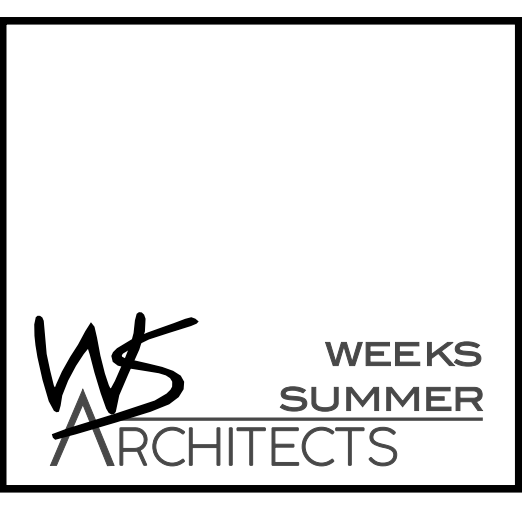

W. S. ARCHITECTS, PA
3305-109 Durham Drive
Raleigh, North Carolina 27603
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NC DEPT. OF INSURANCE 2018 APPENDIX B BUILDING CODE SUMMARY FOR ALL COMMERCIAL PROJECTS (EXCEPT 1 & 2-FAMILY DWELINGS AND TOWNHOUSES)

NC

Name Of Project: BRUNSWICK COUNTY REST AREA & VISTOR CENTER RENOVATION
Address: 394 WHITEVILLE ROAD NW, SHALLOTTE, NC 28470
Zip Code: 28470
Owner Or Authorized Agent: W. S. Architects, PA Phone: (919) 779-9797 E-mail: ginger@wsarchitectspa.com

Owned By: City/County Private State
Code Enforcement Jurisdiction: Town County State

LEAD DESIGN PROFESSIONAL: W. S. ARCHITECTS, PA
Designer FIRM NAME LIC. # TELEPHONE E-MAIL
Architectural: W. S. Architects Ginger S. Sumner 11075 (919) 779-9797 ginger@wsarchitectspa.com
Civil: --- --- --- --- --- ---
Electrical: Burke Design Group Benjamin E. Burke 22038 (919) 771-1916 benburke@nc.rr.com
Fire Alarm: --- --- --- --- --- ---
Plumbing: Burke Design Group Benjamin E. Burke 22038 (919) 771-1916 benburke@nc.rr.com
Mechanical: Burke Design Group Benjamin E. Burke 22038 (919) 771-1916 benburke@nc.rr.com
Sprinkler-Standpipe: --- --- --- --- --- ---
Structural: Lysaght & Assoc. James E. Struffolino 15887 --- --- jes@lysaghtassociates.com
Retaining Walls: --- --- --- --- --- ---
Other: >= High: --- --- --- --- --- ---

2018 NC BUILDING CODE: New Building Shell/Core 1st Time Interior Completions
 Addition Phased Construction - Shell Core
2018 NC EXISTING BUILDING CODE: Prescriptive Alteration Level I Historic Property
 Repair Alteration Level II Change of Use
 Chapter 14 Alteration Level III

CONSTRUCTED: (date) 1990 CURRENT OCCUPANCY(S) (Ch. 3): B
RENOVATED: (date) PROPOSED OCCUPANCY(S) (Ch. 3): B
OCCUPANCY CATEGORY (Table 1604.5): Current: II Proposed: II

BASIC BUILDING DATA
CONSTRUCTION TYPE: I-A II-A III-A IV V-A
 I-B II-B III-B V-B
SPRINKLERS: NO PARTIAL NFPA 13 NFPA 13R NFPA 13D
STANDPIPES: NO CLASS I II III WET DRY
PRIMARY FIRE DISTRICT: NO YES FLOOD HAZARD AREA: NO YES
SPECIAL INSPECTIONS REQUIRED: NO YES

GROSS BUILDING AREA	EXISTING (SF)	NEW (SF)	SUB-TOTAL	TENANT
3RD FLOOR	---	---	---	---
2ND FLOOR	---	---	---	---
MEZZANINE	600	---	600	---
1ST FLOOR	2,435	268	2,703	---
BASEMENT	---	---	---	---
TOTAL	3,036	268	3,303	---

ALLOWABLE AREA:
PRIMARY OCCUPANCY:
 ASSEMBLY A-1 A-2 A-3 A-4 A-5
 BUSINESS
 EDUCATIONAL
 FACTORY F-1 Moderate F-2 Low
 HIGH-HAZARD H-1 Detonate H-2 Deflagrate H-3 Combust H-4 Health H-5 HPM
 INSTITUTIONAL I-1 I-2 I-3 I-4
 I-1 Condition I-2 I-3 I-4
 I-2 Condition I-3 I-4 I-5
 I-3 Condition I-4
 MERCANTILE
 RESIDENTIAL
 STORAGE S-1 Moderate S-2 Low HIGH-PILED
 OPEN ENCLOSED REPAIR GARAGE
 UTILITY & MISCELLANEOUS

ACCESSORY OCCUPANCY CLASSIFICATION(S):
INCIDENTAL USES (Table 509):
This separation is not exempt as a Non-Separated Use (see exceptions).
SPECIAL USES (Chapter 4 - List Code Sections):
SPECIAL PROVISIONS (Chapter 5 - List Code Sections):
MIXED OCCUPANCY: Separation: NON-SEPARATED MIXED USE FOR TENANT Exemption: ---

$$\frac{\text{Actual Area of Occupancy A}}{\text{Allowable Area of Occupancy A}} + \frac{\text{Actual Area of Occupancy B}}{\text{Allowable Area of Occupancy B}} \leq 1$$

STORY NO.	DESCRN AND USE	(A) BLDG AREA PER STORY (ACTUAL)	(B) TABLE 506.2 AREA	(C) AREA FOR OPEN SPACE INCREASE 1.5	(D) ALLOWABLE AREA OR UNLIMITED 2.3
1	B	3,303	9,000	6,750	15,750
---	---	---	---	---	---

ALLOWABLE HEIGHT	ALLOWABLE (TABLES 504.3 & 504.4)	SHOWN ON PLANS	CODE REFERENCE
BUILDING HEIGHT IN FEET	40 (FT)	28 (FT)	---
BUILDING HEIGHT IN STORIES	2 (STORIES ABOVE GRADE PLANE)	1 (STORIES)	---

1. Provide code reference if the "Shown on Plans" quantity is not based on Table 504.3 or 504.4.

NC DEPT. OF INSURANCE 2018 APPENDIX B BUILDING CODE SUMMARY CONTINUED

FIRE PROTECTION REQUIREMENTS BUILDING ELEMENT	FIRE SEPN DIST. (FT)	RATING REQ'D	RATING PROV'D (W/ REDUCTION)	DETAIL # AND SHEET #	DES. # FOR RATED ASSY	DES. # FOR RATED PENETN	DES. # FOR RATED JOINTS
STRUCTURAL FRAME, INCLUDING COLUMNS GIRDERS, TRUSSES BEARING WALLS	≥ 30'	0	0	---	---	---	---
EXTERIOR	---	---	---	---	---	---	---
NORTH	---	---	---	---	---	---	---
EAST	---	---	---	---	---	---	---
WEST	---	---	---	---	---	---	---
SOUTH	---	---	---	---	---	---	---
INTERIOR	---	---	---	---	---	---	---
NONBEARING WALLS AND PARTITIONS	---	---	---	---	---	---	---
EXTERIOR	≥ 30'	0	0	---	---	---	---
NORTH	≥ 30'	0	0	---	---	---	---
EAST	≥ 30'	0	0	---	---	---	---
WEST	≥ 30'	0	0	---	---	---	---
SOUTH	≥ 30'	0	0	---	---	---	---
INTERIOR WALL & PARTITIONS	---	---	---	---	---	---	---
FLOOR CONSTRUCTION INCLUDING SUPPORTING BEAMS AND JOISTS	---	---	---	---	---	---	---
FLOOR CEILING ASSEMBLY	---	---	---	---	---	---	---
COLUMNS SUPPORTING FLOORS	---	---	---	---	---	---	---
ROOF CONSTRUCTION INCLUDING SUPPORTING BEAMS AND JOISTS	---	---	---	---	---	---	---
ROOF CEILING ASSEMBLY	---	---	0	---	---	---	---
COLUMNS SUPPORTING ROOF	---	---	---	---	---	---	---
SHAFTS ENCLOSURES-EXIT	---	---	---	---	---	---	---
SHAFTS ENCLOSURES-OTHER	---	---	---	---	---	---	---
CORRIDOR SEPARATION	---	---	---	---	---	---	---
OCCUPANCY/FIRE BARRIER	---	---	---	---	---	---	---
SEPARATION	---	---	---	---	---	---	---
PARTY/FIRE WALL SEPARATION	---	---	---	---	---	---	---
SMOKE BARRIER SEPARATION	---	---	---	---	---	---	---
SMOKE PARTITION	---	---	---	---	---	---	---
TENANT/DWELLING UNIT/SLEEPING UNIT SEPARATION	---	---	---	---	---	---	---
INCIDENTAL USE SEPARATION	---	---	---	---	---	---	---

PERCENTAGE OF WALL OPENING CALCULATIONS	FIRE SEPARATION DISTANCE (FEET) FROM PROPERTY LINES	DEGREE OF OPENINGS PROTECTION (TABLE 705.8)	ALLOWABLE AREA (%)	ACTUAL SHOWN ON PLANS (%)
---	---	---	---	---

LIFE SAFETY SYSTEM REQUIREMENTS
EMERGENCY LIGHTING: YES NO
EXIT SIGNS: YES NO
FIRE ALARM: YES NO
SMOKE DETECTION SYSTEMS: YES NO
PANIC HARDWARE: YES NO


LIFE SAFETY PLAN REQUIREMENTS SHEET NUMBER A1.0
 FIRE AND/OR SMOKE RATED WALL LOCATIONS (CHAPTER 7)
 ASSUMED AND REAL PROPERTY LINE LOCATIONS (IF NOT ON SITE PLAN)
 EXTERIOR WALL OPENING AREA WITH RESPECT TO DISTANCE TO ASSUMED PROPERTY LINES (705.8)
 OCCUPANCY USE FOR EACH AREA AS IT RELATES TO OCCUPANT LOAD CALCULATION (TABLE 1004.1.2)
 OCCUPANT LOADS FOR EACH AREA
 EXIT ACCESS TRAVEL DISTANCES (1017)
 COMMON PATH OF TRAVEL DISTANCES (1006.2.1 & 1006.3.2(1))
 DEAD END LENGTHS (1020.4)
 CLEAR EXIT WIDTHS FOR EACH EXIT DOOR
 MAXIMUM CALCULATED OCCUPANT LOAD CAPACITY EACH EXIT DOOR CAN ACCOMMODATE BASED ON EGRESS WIDTH (1005.3)
 ACTUAL OCCUPANT LOAD FOR EACH DOOR
 A SEPARATE SCHEMATIC PLAN INDICATING WHERE FIRE RATED FLOOR/CEILING AND/OR ROOF STRUCTURE IS PROVIDED FOR PURPOSES OF OCCUPANCY SEPARATION
 LOCATION OF DOORS WITH PANIC HARDWARE (1010.1.10)
 LOCATION OF DOORS WITH DELAYED EGRESS LOCKS AND THE AMOUNT OF THE DELAY (1010.1.9.7)
 LOCATION OF DOORS WITH ELECTROMAGNETIC EGRESS LOCKS (1010.1.9.9)
 LOCATION OF DOORS EQUIPPED WITH HOLD-OPEN DEVICES
 LOCATION OF EMERGENCY ESCAPE WINDOWS (1030)
 THE SQUARE FOOTAGE OF EACH FIRE AREA (202)
 THE SQUARE FOOTAGE OF EACH SMOKE COMPARTMENT FOR OCCUPANCY CLASSIFICATION I-2 (407.5)
 NOTE ANY CODE EXCEPTIONS ON TABLE NOTES THAT MAY HAVE BEEN UTILIZED REGARDING THE ITEMS ABOVE

TOTAL UNITS	ACCESSIBLE UNITS REQ'D	ACCESSIBLE UNITS PROV'D	TYPE A UNITS REQ'D	TYPE A UNITS PROV'D	TYPE B UNITS REQ'D	TYPE B UNITS PROV'D	TOTAL ACCESSIBLE UNITS PROV'D
---	---	---	---	---	---	---	---

LOT OR PARKING AREA	TOTAL # OF SPACES REQ'D	# OF ACCESSIBLE SPACES PROVIDED	TOTAL # ACCESSIBLE PROVIDED
---	---	---	---

SPACE	EXIST'G REQ'D	WATERCLOSETS			URINALS			LAVATORIES			SHOWERS/ TUBS		DRINKING FOUNTAINS	
		MALE	FEMALE	UNISEX	MALE	FEMALE	UNISEX	MALE	FEMALE	UNISEX	REGULAR	ACCESSIBLE		
---	---	---	---	---	---	---	---	---	---	---	---	---	---	---
---	---	---	---	---	---	---	---	---	---	---	---	---	---	---

SPECIAL APPROVALS
Special Approval: (Local Jurisdiction, Dept of Insurance, OSC, DPI, DHHS, etc., describe below)

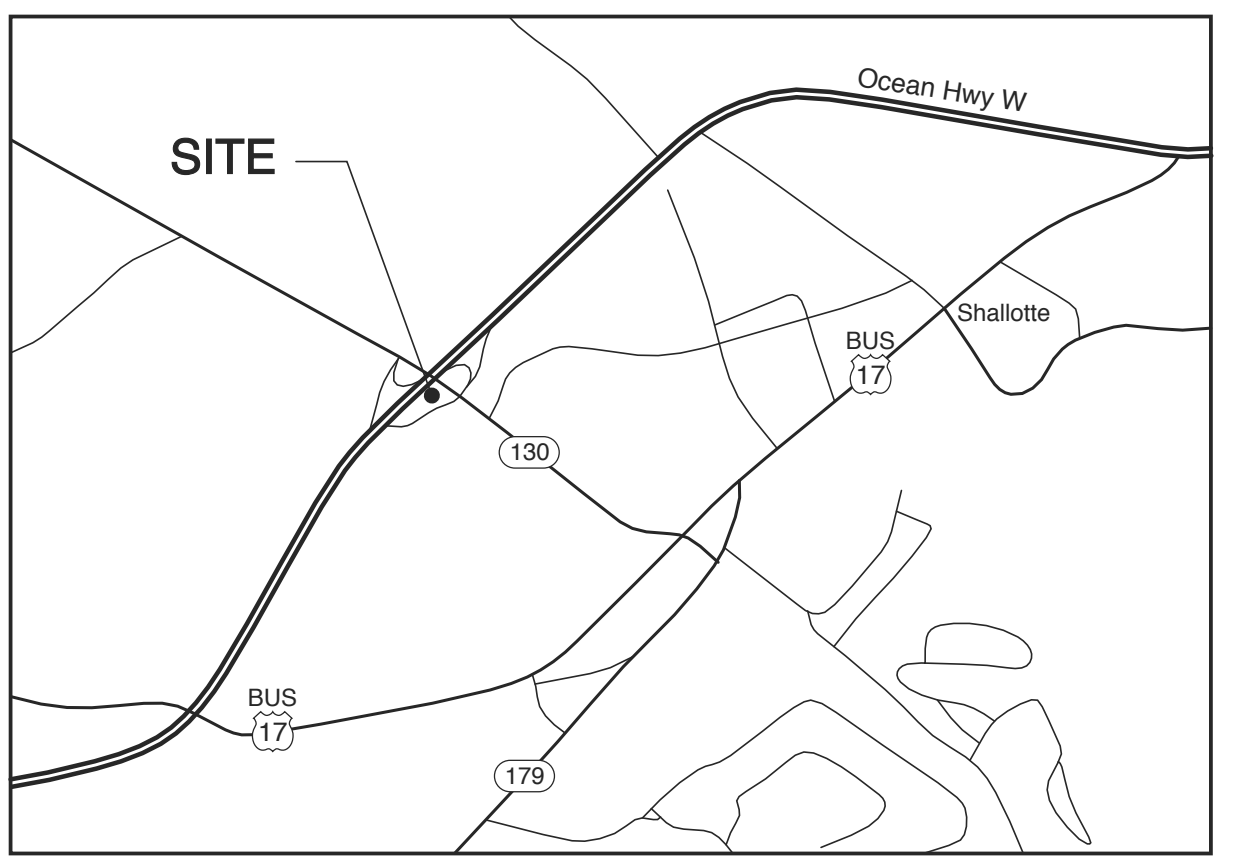

1 VICINTY MAP SCALE: NTS

NC DEPT. OF INSURANCE 2018 APPENDIX B BUILDING CODE SUMMARY CONTINUED

COMcheck Software Version COMcheckWeb Envelope Compliance Certificate

Project Information
Energy Code: 90.1 (2013) Standard
Project Title: Brunswick
Location: Shallotte, North Carolina
Climate Zone: 3a
Project Type: New Construction
Vertical Glazing / Wall Area: 31%
Performance Sim. Specs: EnergyPlus 8.1.0.009 (EPW: USA_NC_Wilmington.Intl.AP.723013_TMY3.epw)

Building Area	Floor Area
1-Retail : Nonresidential	1133

Envelope Assemblies	Gross Area or Perimeter	Cavity R-Value	Cont. R-Value	Proposed U-Factor	Budget U-Factor
Roof: Attic Roof, Wood Joists, (Bldg. Use 1 - Retail)	260	42.0	0.0	0.024	0.027
NORTH					
Ext. Wall: Wood-Framed, 24in. o.c., (Bldg. Use 1 - Retail)	849	19.0	5.0	0.047	0.089
Window: Other Window: Fixed, Perf. Specs.: Product ID tribaf, SHGC 0.25, PF 0.10, VT 0.55, (Bldg. Use 1 - Retail) (c)	246	---	---	0.550	0.350
Door: Glass (over 50% glazing): Metal Frame, Entrance Door, Perf. Specs.: Product ID storefront, SHGC 0.25, VT 0.55, (Bldg. Use 1 - Retail) (c)	42	---	---	0.770	0.770
EAST					
Ext. Wall: Wood-Framed, 24in. o.c., (Bldg. Use 1 - Retail)	849	19.0	5.0	0.047	0.089
Window: Other Window: Fixed, Perf. Specs.: Product ID tribaf, SHGC 0.25, PF 0.10, VT 0.55, (Bldg. Use 1 - Retail) (c)	51	---	---	0.550	0.350
Window: Other Window: Fixed, Perf. Specs.: Product ID tribaf, SHGC 0.25, PF 0.10, VT 0.55, (Bldg. Use 1 - Retail) (c)	288	---	---	0.550	0.350
SOUTH					
Ext. Wall: Wood-Framed, 24in. o.c., (Bldg. Use 1 - Retail)	849	19.0	5.0	0.047	0.089
Window: Other Window: Fixed, Perf. Specs.: Product ID tribaf, SHGC 0.25, PF 0.10, VT 0.55, (Bldg. Use 1 - Retail) (c)	164	---	---	0.550	0.350

(a) Budget U-factors are used for software baseline calculations ONLY, and are not code requirements.
(b) 'Other' components require supporting documentation for proposed U-factors.
(c) Fenestration product performance must be certified in accordance with NFRC and requires supporting documentation.
Envelope PASSES: Design 1% better than code

Envelope Compliance Statement
Compliance Statement: The proposed envelope design represented in this document is consistent with the building plans, specifications, and other calculations submitted with this permit application. The proposed envelope systems have been designed to meet the 90.1 (2013) Standard requirements in COMcheck Version COMcheckWeb and to comply with any applicable mandatory requirements listed in the Inspection Checklist.
Ginger Sumner
Signature: [Signature] Date: 4/28/2022

STRUCTURAL DESIGN (COPIED FROM STRUCTURAL NOTE SHEET)
CODE: NORTH CAROLINA STATE BUILDING CODE - 2018 EDITION (IBC 2015)
STRUCTURAL LOADING PER ASCE 7-2010
BUILDING RISK CATEGORY (NCSCB 2018 TABLE 1604.5) II

DESIGN LOADS:
ROOF LIVE LOAD 20 PSF
FLOOR LIVE LOAD (Main Floor) 100 PSF
FLOOR LIVE LOAD (Upper Level Office) 50 PSF

SNOW LOAD DATA:
GROUND SNOW LOAD 10 PSF
SNOW EXPOSURE FACTOR 1.0
SNOW LOAD IMPORTANCE FACTOR 1.0
THERMAL FACTOR 1.1
FLAT ROOF SNOW LOAD 12.7 PSF
ROOF SLOPE FACTOR 1.0
PITCHED ROOF SNOW LOAD 7.7 PSF

WIND LOAD DATA:
ULTIMATE DESIGN WIND SPEED, Vult 147 MPH
NOMINAL DESIGN WIND SPEED, Vwd 114 MPH
WIND EXPOSURE "B" w/ Open Patches
INTERNAL PRESSURE COEFFICIENTS (Addition) 0.18, -0.18
WIND BASE SHEAR (Addition, x= Direction) 7.5 KIPS
WIND BASE SHEAR (Addition, y= Direction) 11.3 KIPS
INTERNAL PRESSURE COEFFICIENTS (Covered Entry) +0.0, -0.0
WIND BASE SHEAR (Covered Entry, x= Direction) 2.4 KIPS
WIND BASE SHEAR (Covered Entry, y= Direction) 2.1 KIPS
WIND PRESSURE FOR COMPONENTS / CLADDING PER ASCE 7-10

SEISMIC LOAD DATA:
SEISMIC IMPORTANCE FACTOR I 1.00
MAPPED SPECTRAL RESPONSE ACCELERATION Ss 0.293
MAPPED SPECTRAL RESPONSE ACCELERATION S1 0.115
SITE CLASS D
SPECTRAL RESPONSE COEFFICIENT SDS 0.306
SPECTRAL RESPONSE COEFFICIENT SD1 0.179

BASIC STRUCTURAL SYSTEM (Addition) Bearing Wall System
SEISMIC RESISTING SYSTEM Light Framed Walls w/ Shear Panels
RESPONSE MODIFICATION COEFFICIENT R 6.50
SYSTEM OVERSTRENGTH FACTOR Omega 3.00
DEFLECTION AMPLIFICATION FACTOR Cd 4.00
SEISMIC RESPONSE COEFFICIENT Cs 0.047
ANALYSIS PROCEDURE Equivalent Lateral Force
SEISMIC BASE SHEAR (Addition) 1.7 KIPS
BASIC STRUCTURAL SYSTEM (Covered Entry) Cantilevered Column System
SEISMIC RESISTING SYSTEM Steel Ordinary Cantilevered Column
RESPONSE MODIFICATION COEFFICIENT R 1.25
SYSTEM OVERSTRENGTH FACTOR Omega 1.25
DEFLECTION AMPLIFICATION FACTOR Cd 1.25
SEISMIC RESPONSE COEFFICIENT Cs 0.245
ANALYSIS PROCEDURE Equivalent Lateral Force
SEISMIC BASE SHEAR (Covered Entry) 1.3 KIPS

SCOPE OF WORK:

- NEW EXT. ENVELOPE FOR VISTOR CENTER
- ADDITION OF FAMILY RESTROOM
- NEW RESTROOM ENTRANCE CANOPY

DRAWING INDEX

A0.1	COVER SHEET
A1.0	SITE / LIFE SAFETY PLAN
A1.1	DEMO PLAN / DEMO ELEVATIONS
A1.2	REV. FLOOR PLAN
A1.3	FINISH PLAN
A1.4	RCF & ROOF PLAN, INT. ELEVATIONS
A2	REVISED ELEVATIONS
A3.0	BUILDING SECTIONS
A3.1	WALL SECTIONS
A3.2	WALL SECTIONS
A4	SCHEDULES
A5	DETAILS
S0	STRUCTURAL NOTES
S1	FOUNDATION PLAN
S2	ROOF FRAMING PLAN & 2ND FLR
S2A	WALL ELEV. & LINTEL SCHEDULE
S3	FOUNDATION & FRAMING DETAILS
S4	FRAMING DETAILS
S5	FRAMING DETAILS
S6	FRAMING DETAILS
P1	PLUMBING SPECIFICATIONS
P2	DWV PLAN
P3	WATER PLAN
M1	HVAC SCHEDULES, NOTES
M2	EXISTING HVAC PLAN
M3	NEW HVAC PLAN
M4	HVAC DETAILS
E1	ELECTRICAL DETAILS/SPECS
E2	EXISTING ELEC. PLAN
E3	NEW ELEC PLAN
E4	ELECT. PANEL S RISERS

BID SET 4.28.22

WBS: 15RE.13.3

SCO ID# 21-24079-01A

PROJECT TITLE
BRUNSWICK CTY. REST AREA-RENOV.
US 17 AT NC 130
SHALLOTTE, NORTH CAROLINA


PROJECT NO.
2104a
DRAWING TITLE
COVER SHEET

SHEET 1 OF 12


A.O.O.

PLOT DATE 4/28/22
REVISION 00/00/21

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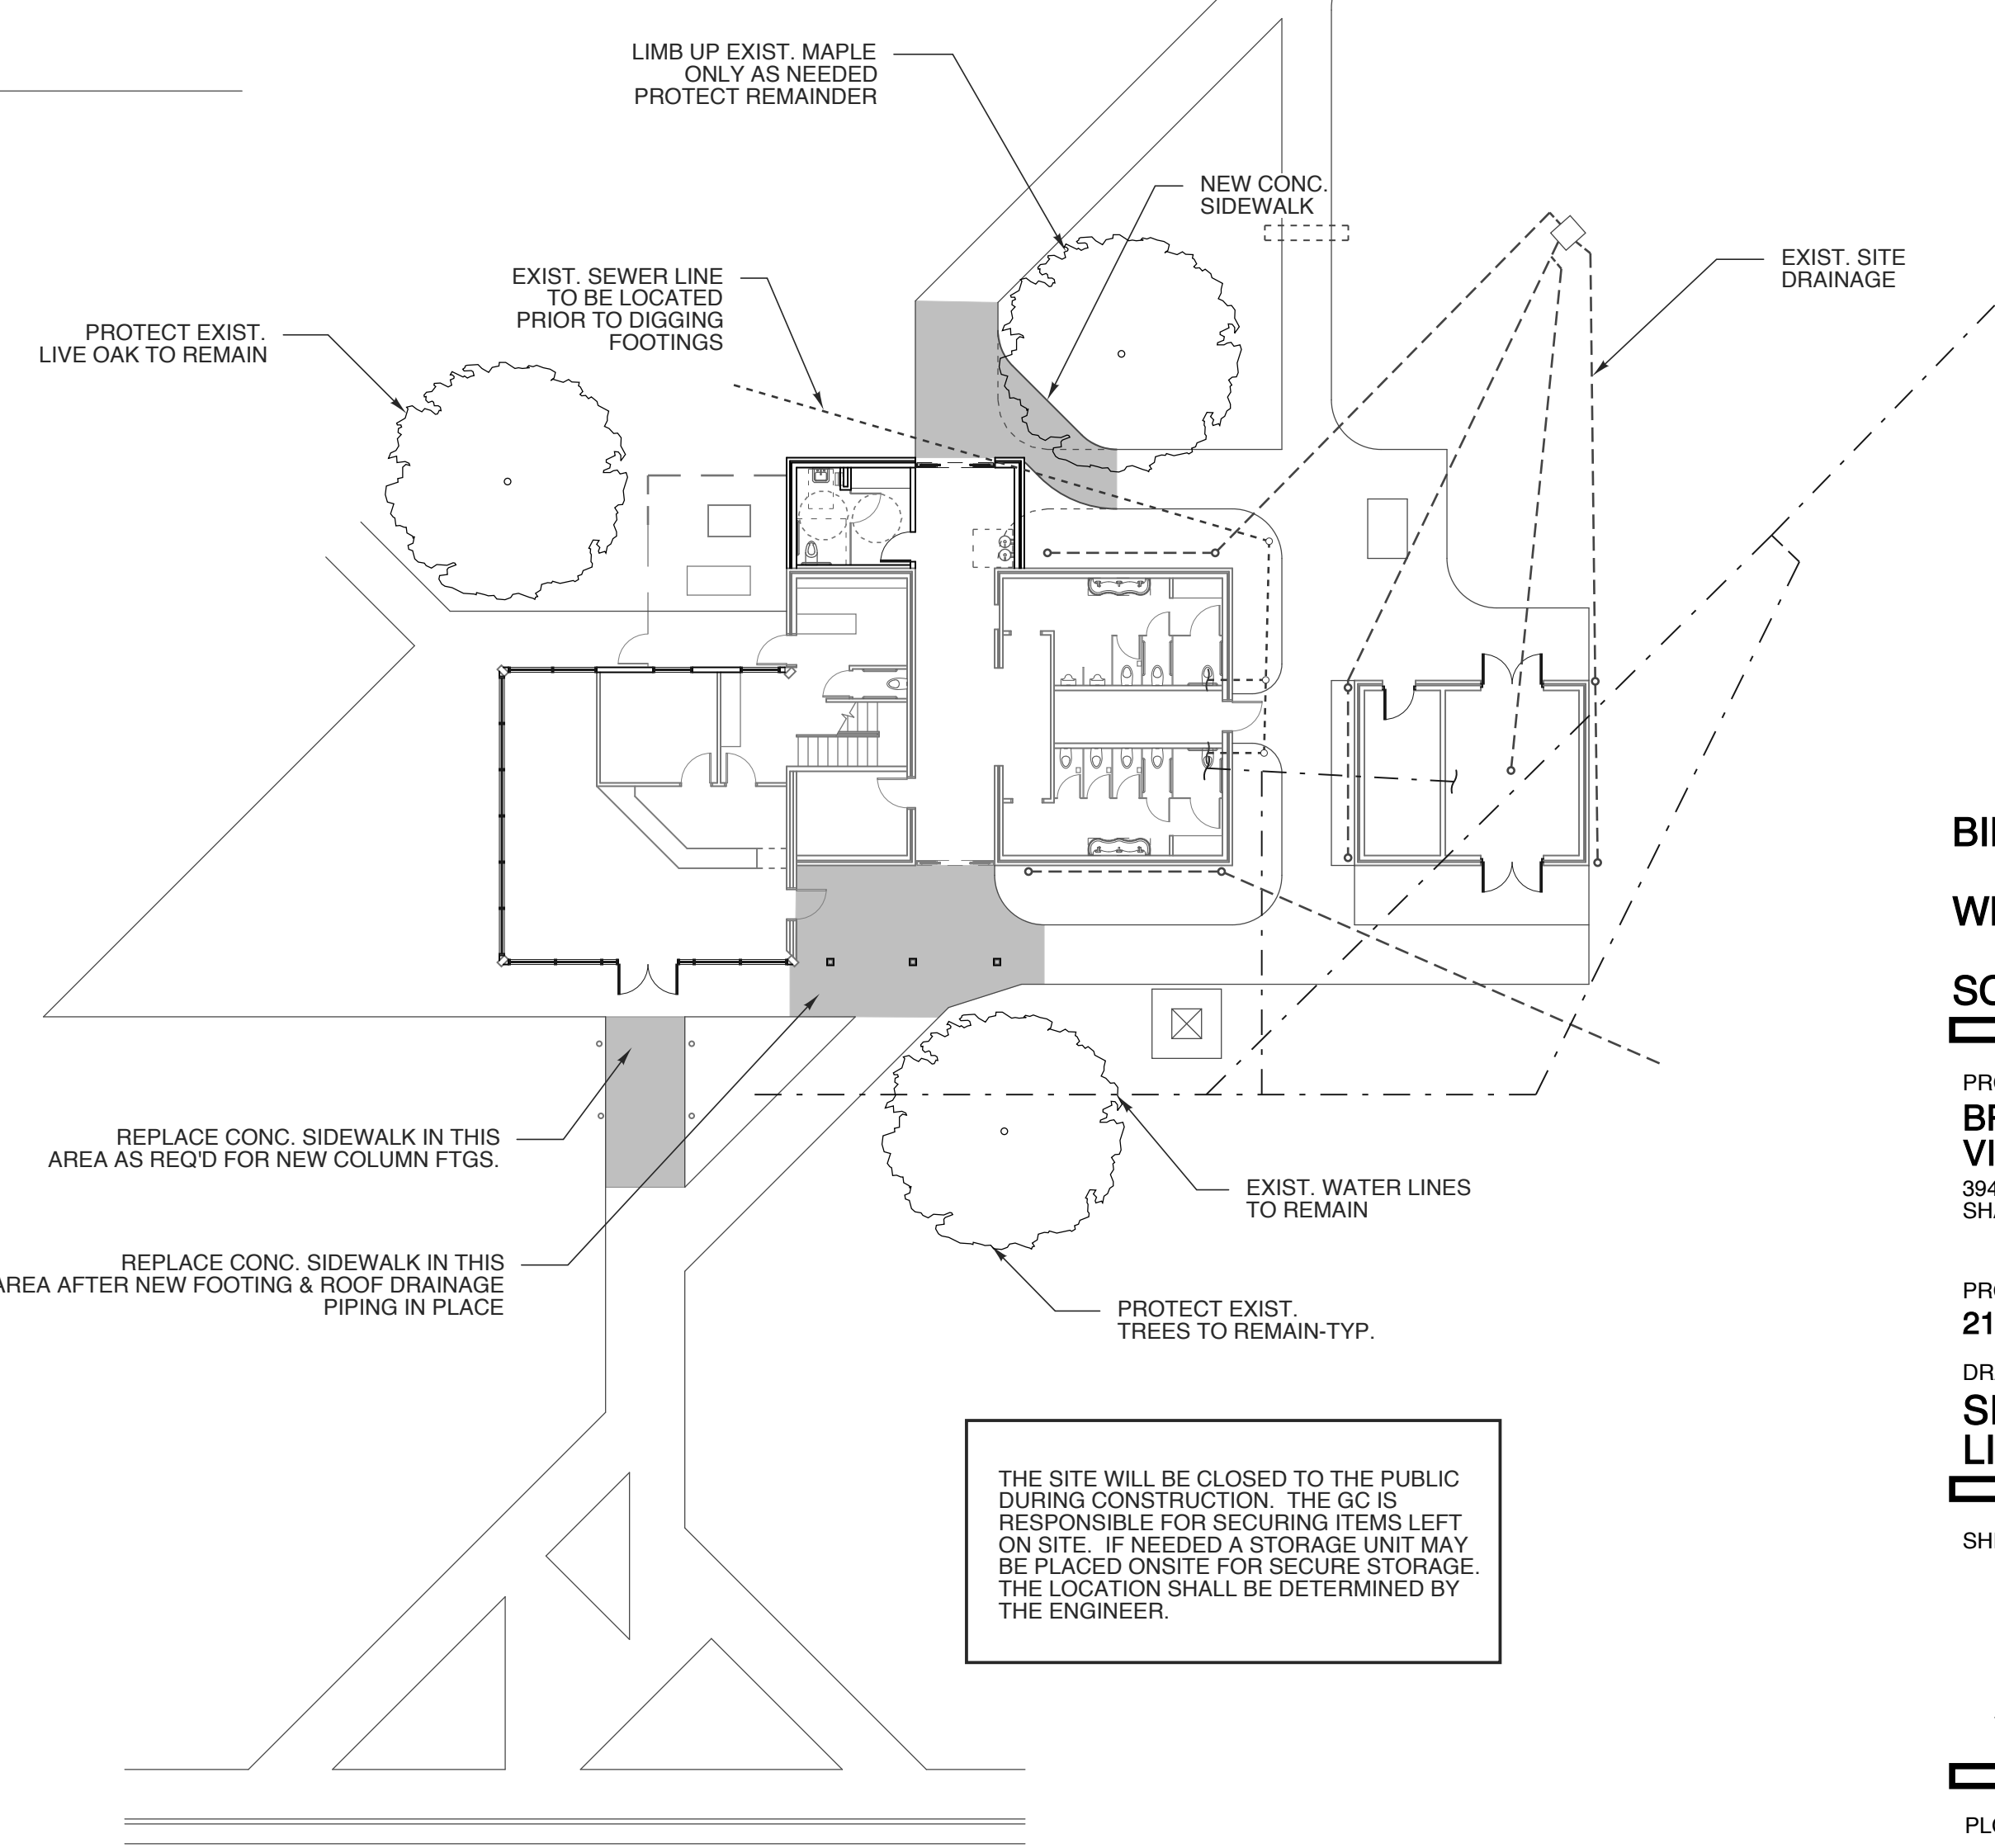
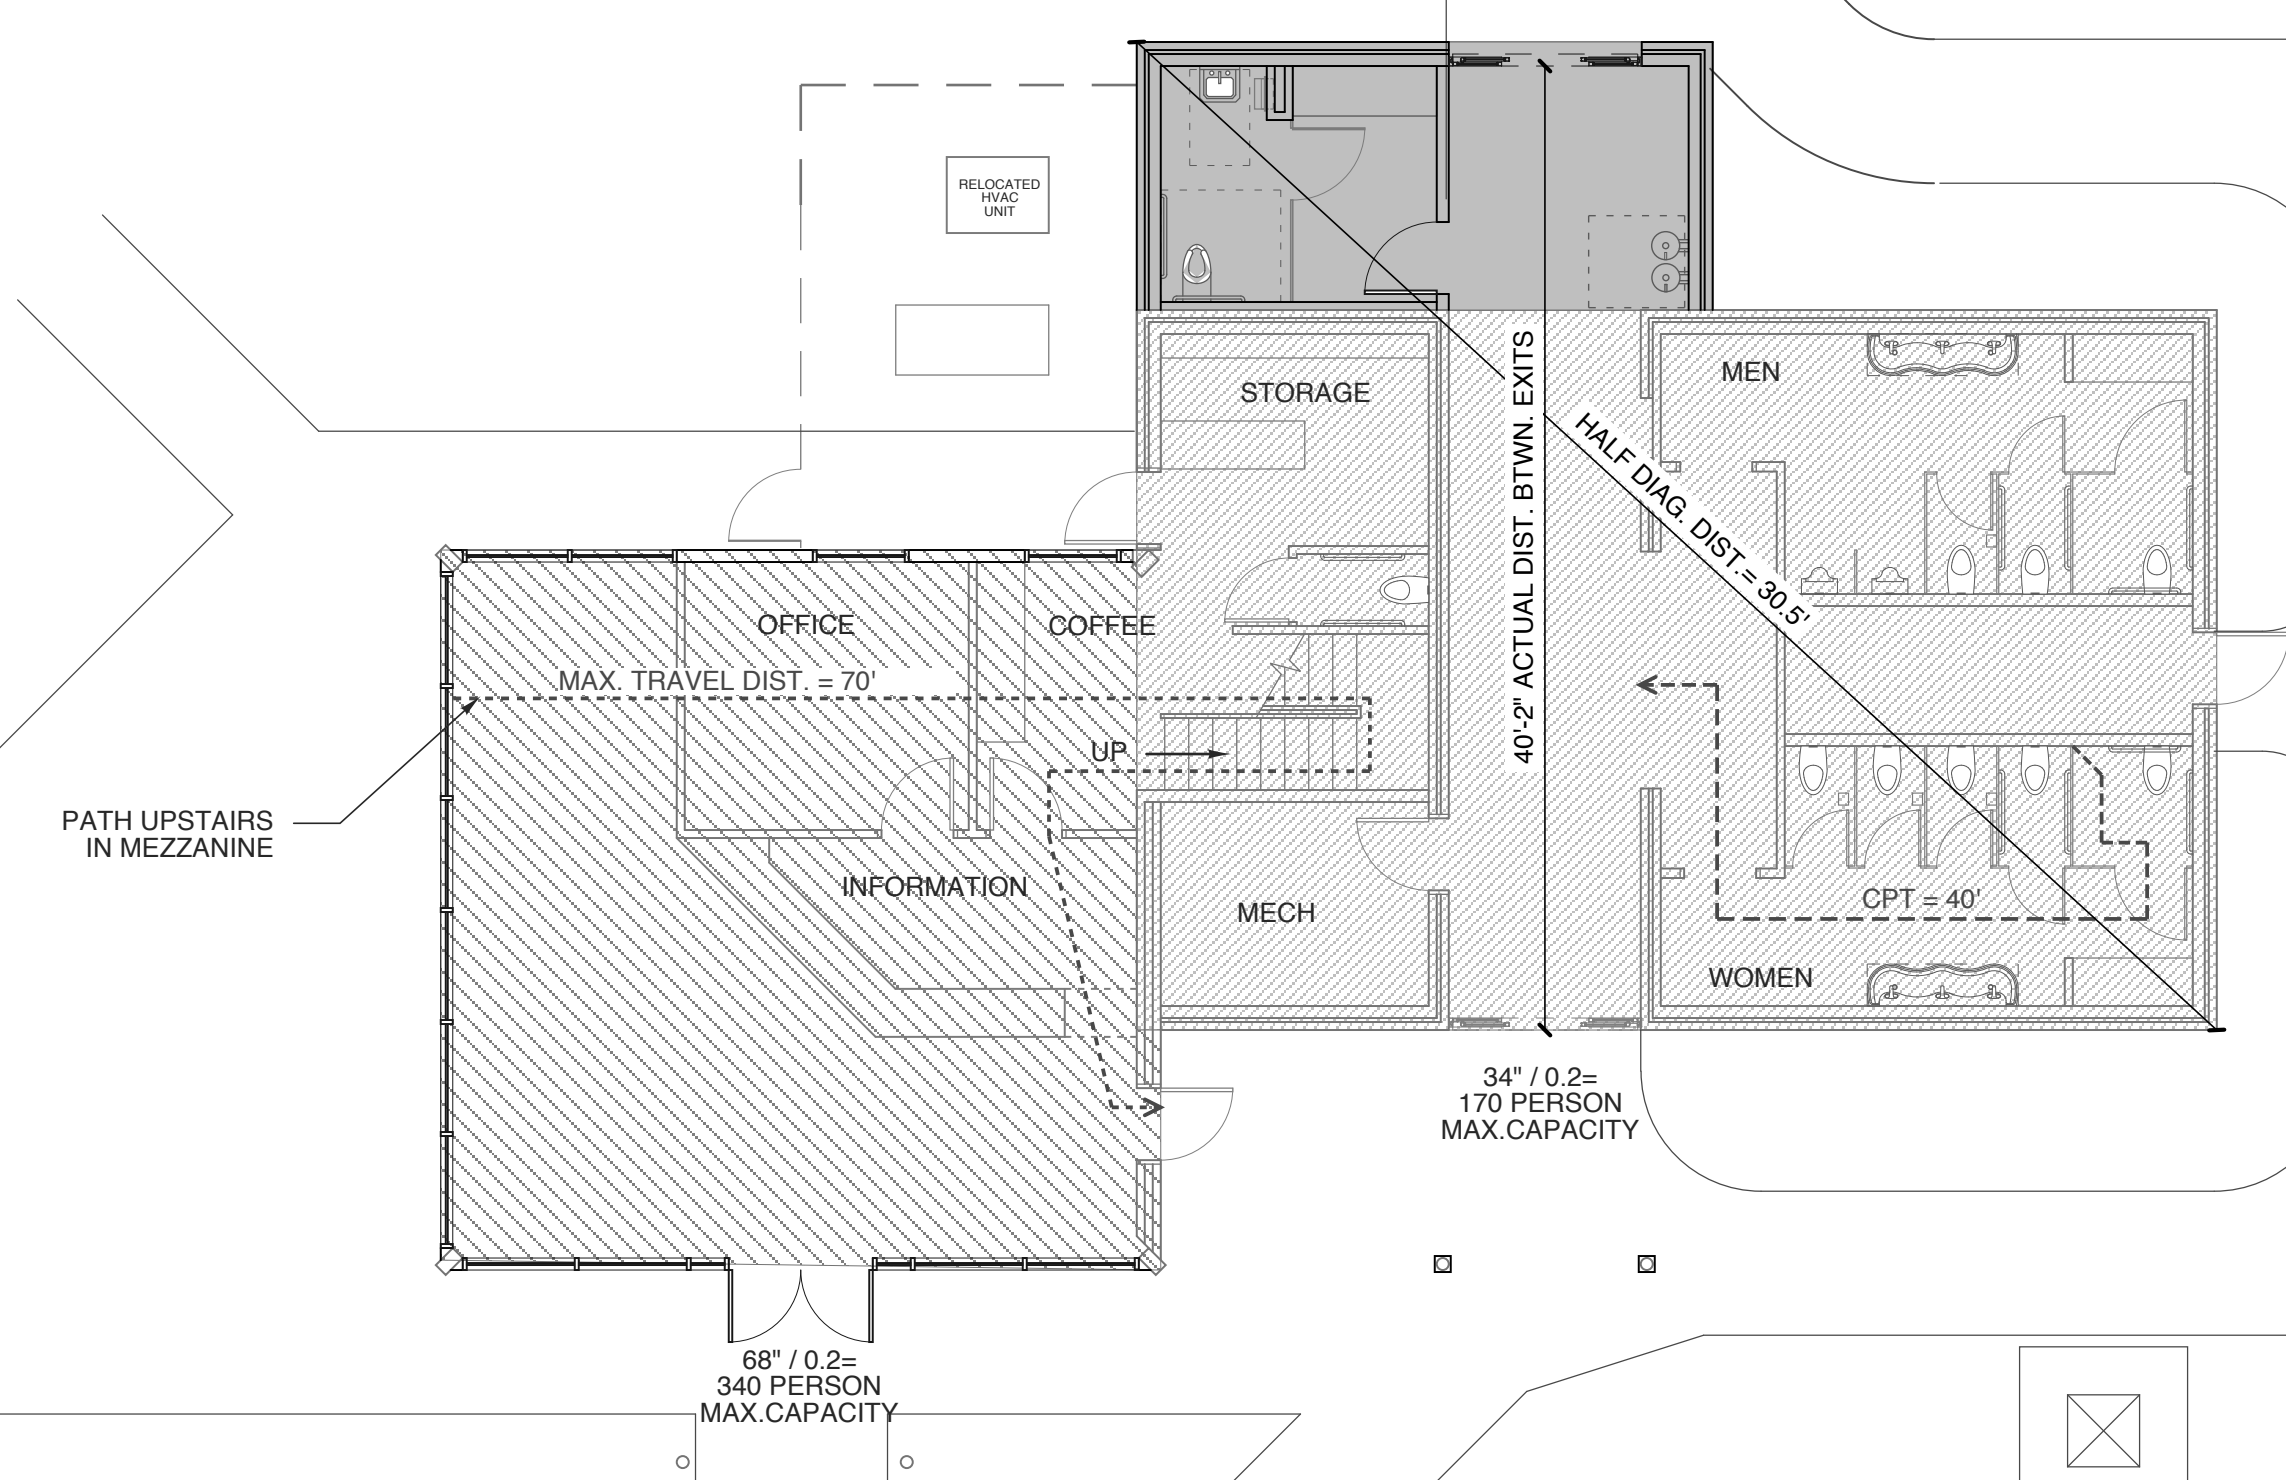
AREAS	
1,350 SF	EXISTING REST AREA
877 SF +600 MEZZ.	EXISTING VISITOR CENTER
208 SF	EXISTING PORCH AREA
268 SF	NEW FAMILY RESTROOM
3,303 SF	TOTAL AREA

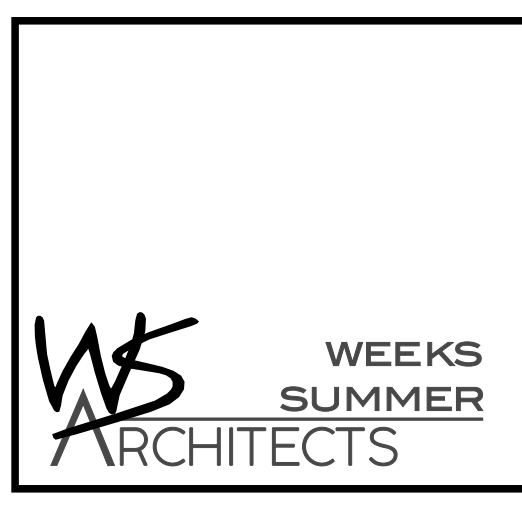EGRESS REQ. & CODE REF.

REST AREA
USE: BUSINESS
3,303 SF/100 = 34 PEOPLE
34 x 0.2" = 6.8" CLEAR EGRESS WIDTH PER 1005.1 OF NCIBC

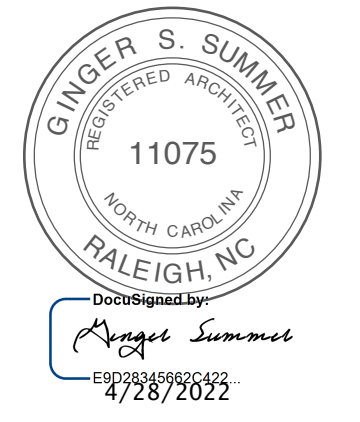DOORS TO HAVE 32" MIN. CLR. PER 404.2.2 OF ANSI A117.1

THE CLEAR WIDTH OF INTERIOR ACCESSIBLE ROUTE IS 36" MIN. PER 403.5 OF ANSI A117.1



GENERAL NOTES

I: FOR THIS PROJECT:

A) THE ARCHITECTS SCOPE OF WORK DOES INCLUDE CONSTRUCTION OBSERVATION.

THE CONTRACTOR IS IN CHARGE OF THE WORK AND COMPLIANCE WITH THESE CONSTRUCTION DOCUMENTS IS THE SOLE RESPONSIBILITY OF THE CONTRACTOR. THE ARCHITECT WILL BEAR NO RESPONSIBILITY FOR FAILURE OF THE CONTRACTOR TO FULLY COMPLY WITH ALL CONSTRUCTION DOCUMENTS.

USE OF THESE CONTRACT DOCUMENTS WILL CONSTITUTE AGREEMENT BY THE CONTRACTOR TO THESE CONDITIONS.

B) "THE GENERAL CONDITIONS OF THE CONTRACT FOR THE CONSTRUCTION OF THE BUILDINGS" OF THE AMERICAN INSTITUTE OF ARCHITECTS DOCUMENT A-201, LATEST EDITION, ARE HEREBY MADE PART OF THE CONTRACT DOCUMENTS. IN THE EVENT OF A CONFLICT, THESE GENERAL NOTES AND CONTRACT SUPERSEDE "AIA DOCUMENT A-201".

II: ALL WORK UNDER THIS CONTRACT SHALL:

A) CONFORM TO STATE, LOCAL AND NATIONAL CODES AND ORDINANCES AS ARE APPLICABLE TO THE WORK INCLUDING BUT NOT LIMITED TO THE NORTH CAROLINA STATE BUILDING CODE, THE AMERICANS WITH DISABILITIES ACT (ADA), NATIONAL ELECTRIC CODES, ASTM SPECIFICATIONS, AND OSHA SAFETY REGULATIONS.

B) COMPLY WITH ALL LAWS, ORDINANCES, CODES, RULES AND REGULATIONS PERTAINING TO ENVIRONMENTAL PROTECTION (EPA). THE COST OF ALL REQUIRED INSPECTIONS AND PERMITS SHALL BE THE RESPONSIBILITY OF THE CONTRACTOR.

III: UNLESS OTHERWISE DIRECTED BY THE ARCHITECT, THE CONTRACTOR SHALL:

A) SUPPLY AND PAY FOR ALL LABOR, TRANSPORTATION, MATERIALS, TOOLS, APPARATUS, LIGHTS, POWER, HEAT, SANITARY FACILITIES, WATER, SCAFFOLDING, AND INCIDENTALS NECESSARY FOR THE COMPLETION OF HIS WORK.

B) INSTALL, MAINTAIN AND REMOVE ALL EQUIPMENT, OTHER UTENSILS OR THINGS USED FOR THE CONSTRUCTION PRIOR TO TURNING OVER THE PROJECT. IF SUCH ITEMS ARE LEFT AFTER COMPLETION OF THE PROJECT, THEY SHALL BECOME PROPERTY OF THE OWNER. THE OWNER MAY PROMPTLY DISPOSE OF SUCH ITEMS, AND WILL NOT BE SUBJECT TO CLAIMS OF THE CONTRACTOR RESULTING FROM SUCH DISPOSITION.

C) CONSTRUCT IN THE BEST AND PROFESSIONAL MANNER, A COMPLETE JOB AND EVERYTHING INCIDENTAL THERETO, AS SHOWN OR REASONABLY IMPLIED FROM THE PLANS, ALL WORK SHALL BE COMPLETED IN ACCORDANCE WITH THE CONTRACT DOCUMENTS.

D) VERIFY ALL DIMENSIONS AND CONDITIONS PRIOR TO PROCEEDING WITH THE WORK AND NOTIFY THE ARCHITECT IN WRITING OF ANY DISCREPANCIES DISCOVERED OR LACK OF REQUIRED INFORMATION TO REQUEST CLARIFICATION. IF THE CONTRACTOR OBSERVES THE CONTRACT DOCUMENTS TO BE CONTRARY TO GOVERNING LAWS, ORDINANCES, CODES, RULES AND REGULATIONS OR OTHERWISE QUESTIONABLE CONDITIONS, HE SHALL PROMPTLY NOTIFY THE ARCHITECT IN WRITING FOR INSTRUCTIONS PRIOR TO PROCEEDING WITH THE WORK.

E) KEEP THE BUILDING AND SURROUNDING AREA REASONABLY FREE FROM RUBBISH AT ALL TIMES. AT A MINIMUM, DEBRIS SHALL BE REMOVED FROM THE SITE ON A WEEKLY BASIS OR AS DIRECTED BY PROJECT EXPEDITOR.

F) LOCATE ALL EXISTING UTILITIES. THE CONTRACTOR MAY NOT INTERFERE WITH ADJACENT UTILITIES UNLESS PRIOR NOTICE AND PERMISSION IS RECEIVED FROM THOSE WHO MAY AS A RESULT OF THIS INTERFERENCE BE AFFECTED.


G) PRIOR TO ANY WORK, CALL "NC ONE CALL CENTER" @ 800-632-4949 AND OTHER LOCATING SERVICES AS TO CONFIRM LOCATION OF UTILITIES.

H) PRIOR TO FINAL INSPECTION AND ACCEPTANCE OF THE BUILDING, EACH CONTRACTOR SHALL CLEAN HIS PORTION OF THE WORK, INCLUDING GLASS, HARDWARE FIXTURES, MASONRY, TILE AND MARBLE (USING NO ACID), CLEAN AND WAX ALL FLOORS AS SPECIFIED, AND COMPLETELY PREPARE THE BUILDING FOR USE BY THE OWNER.


I) FILE WITH THE OWNER CURRENT INSURANCE CERTIFICATIONS IN THE AMOUNTS REQUESTED BY THE OWNER FOR BUILDER'S RISK, WORKMENS COMPENSATION, COMPREHENSIVE GENERAL LIABILITY, BODILY INJURY AND PROPERTY DAMAGE. THIS INSURANCE SHALL INDEMNIFY THE OWNER AND THE ARCHITECT OF ANY AND ALL COSTS, CLAIMS, SUITS AND JUDGEMENTS FOR PROPERTY DAMAGE AND PERSONAL INJURY (INCLUDING GENERAL) ARISING OUT OF THE CONTRACTOR'S ACTIONS.

J) PROVIDE ALL NECESSARY SAFETY MEASURES FOR THE PROTECTION OF ALL PERSONS OF THE WORK, INCLUDING THE REQUIREMENTS OF THE A.G.C. ACCIDENT PREVENTION MANUAL IN CONSTRUCTION AS AMENDED, AND SHALL FULLY COMPLY WITH ALL STATE LAWS OR REGULATIONS AND NORTH CAROLINA STATE BUILDING CODE REQUIREMENTS TO PREVENT ACCIDENT OR INJURY TO PERSONS ON OR ABOUT THE LOCATION OF THE WORK.


K) CLEARLY MARK OR POST SIGNS WARNING OF HAZARDS EXISTING, AND BARRICADE EXCAVATIONS, ELEVATOR SHAFTS, STAIRWELLS AND SIMILAR HAZARDS. PROTECT AGAINST DAMAGE OR INJURY RESULTING FROM FALLING MATERIALS AND MAINTAIN ALL PROTECTIVE DEVICES AND SIGNS THROUGHOUT THE PROGRESS OF THE WORK.

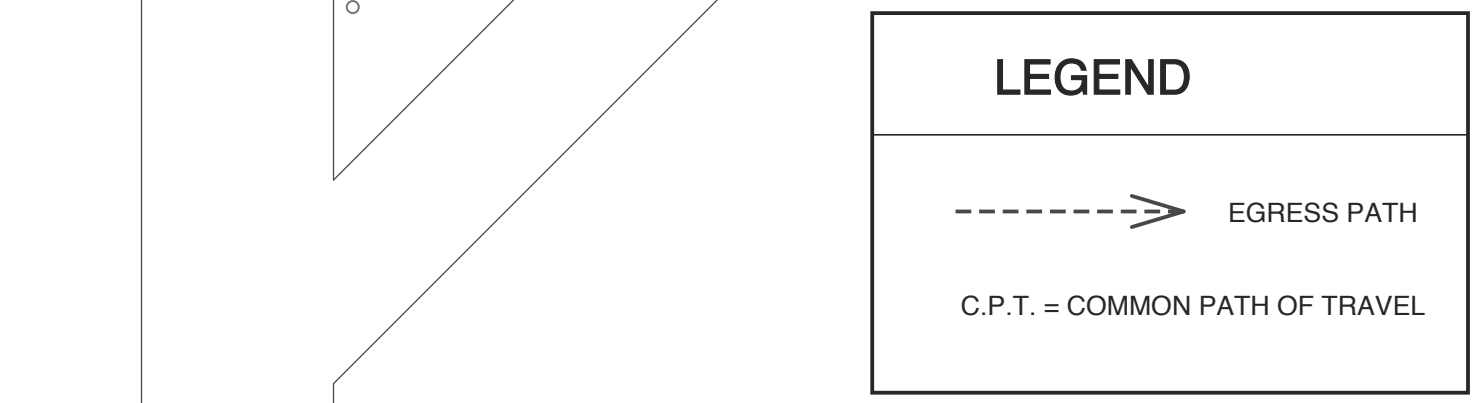

2 LIFE SAFETY PLAN
SCALE: 1/8" = 1'-0"

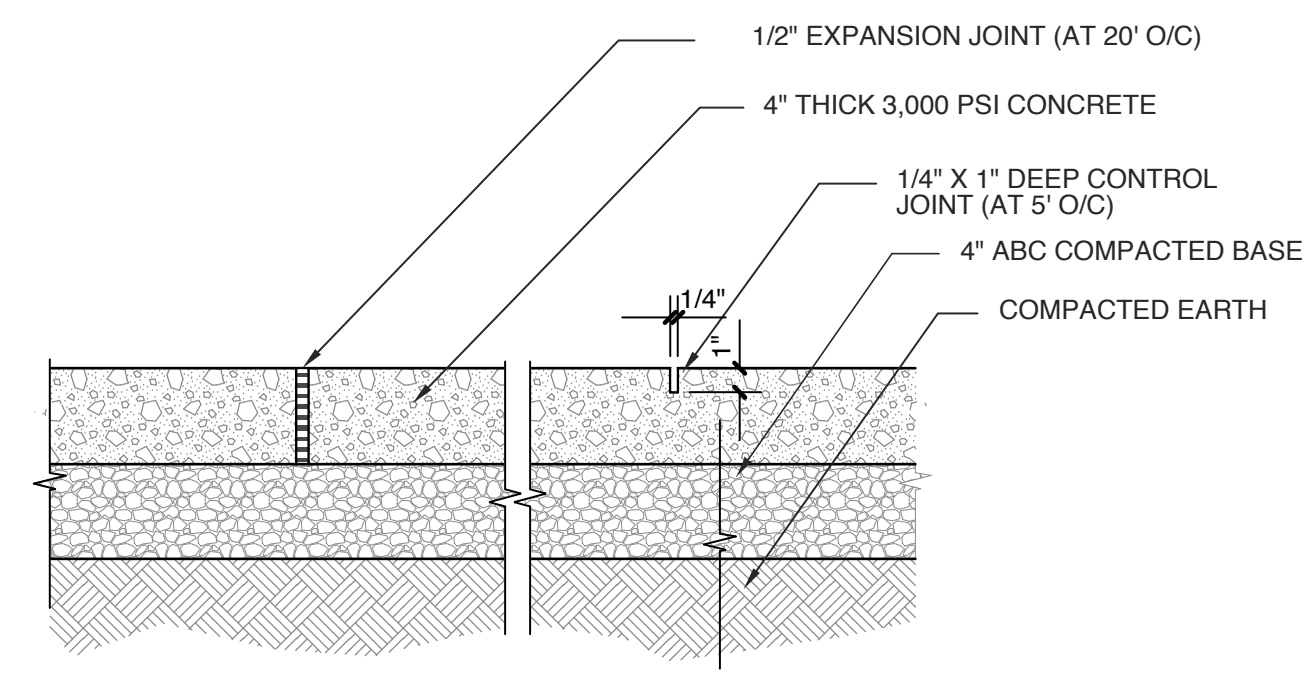


3 CONCRETE WALK DETAILS
SCALE: 1 1/2" = 1'-0"

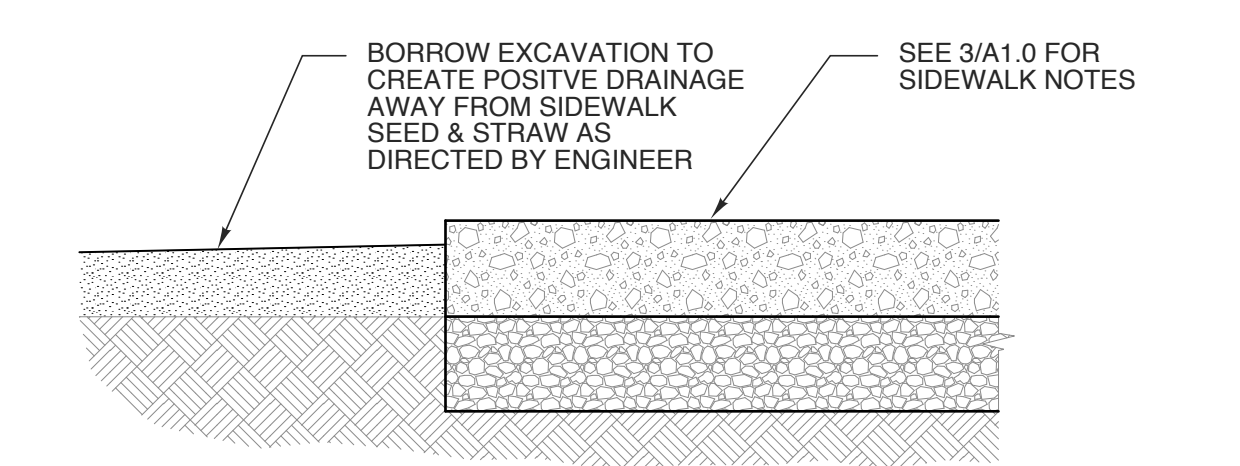

4 CONCRETE WALK DETAILS
SCALE: 1 1/2" = 1'-0"

1 SITE PLAN
SCALE: 1/16" = 1'-0"

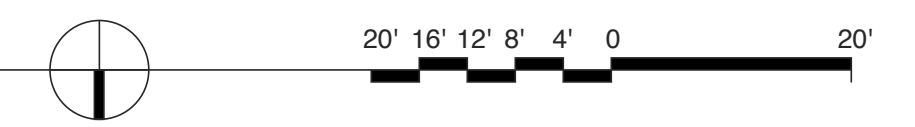

THE SITE WILL BE CLOSED TO THE PUBLIC DURING CONSTRUCTION. THE GC IS RESPONSIBLE FOR SECURING ITEMS LEFT ON SITE. IF NEEDED A STORAGE UNIT MAY BE PLACED ONSITE FOR SECURE STORAGE. THE LOCATION SHALL BE DETERMINED BY THE ENGINEER.

BID SET 4.28.22
WBS: 15RE.13.3
SCO ID# 21-24079-01A

PROJECT TITLE
BRUNSWICK CTY VISTOR'S CENTER
394 WHITEVILLE ROAD NW
SHALLOTE, NORTH CAROLINA

PROJECT NO.
2104a

DRAWING TITLE
SITE PLAN LIFE SAFETY PLAN


SHEET 2 OF 12

A1.0



PLOT DATE
REVISION 00/00/14

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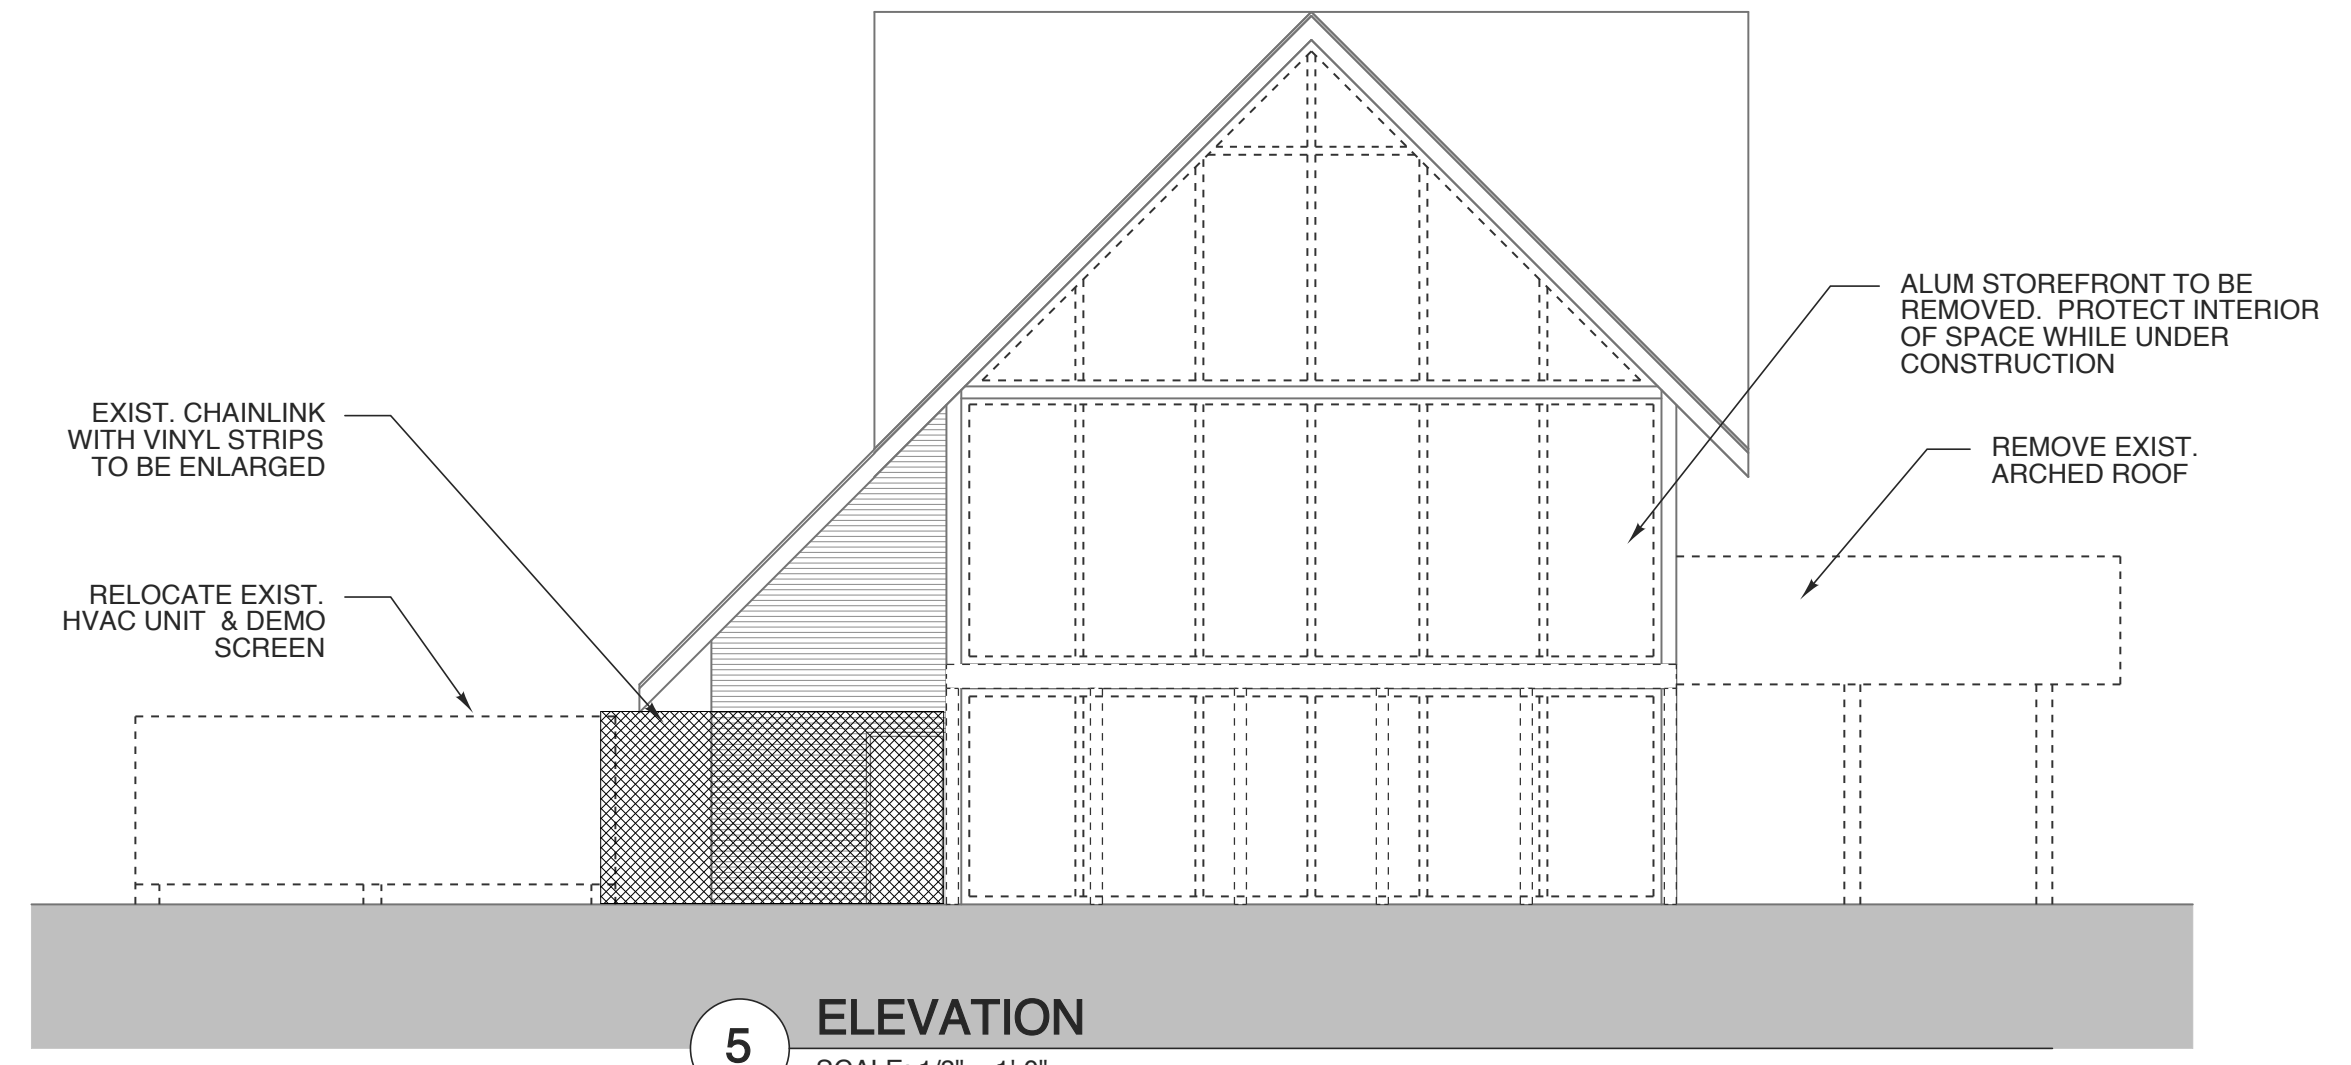
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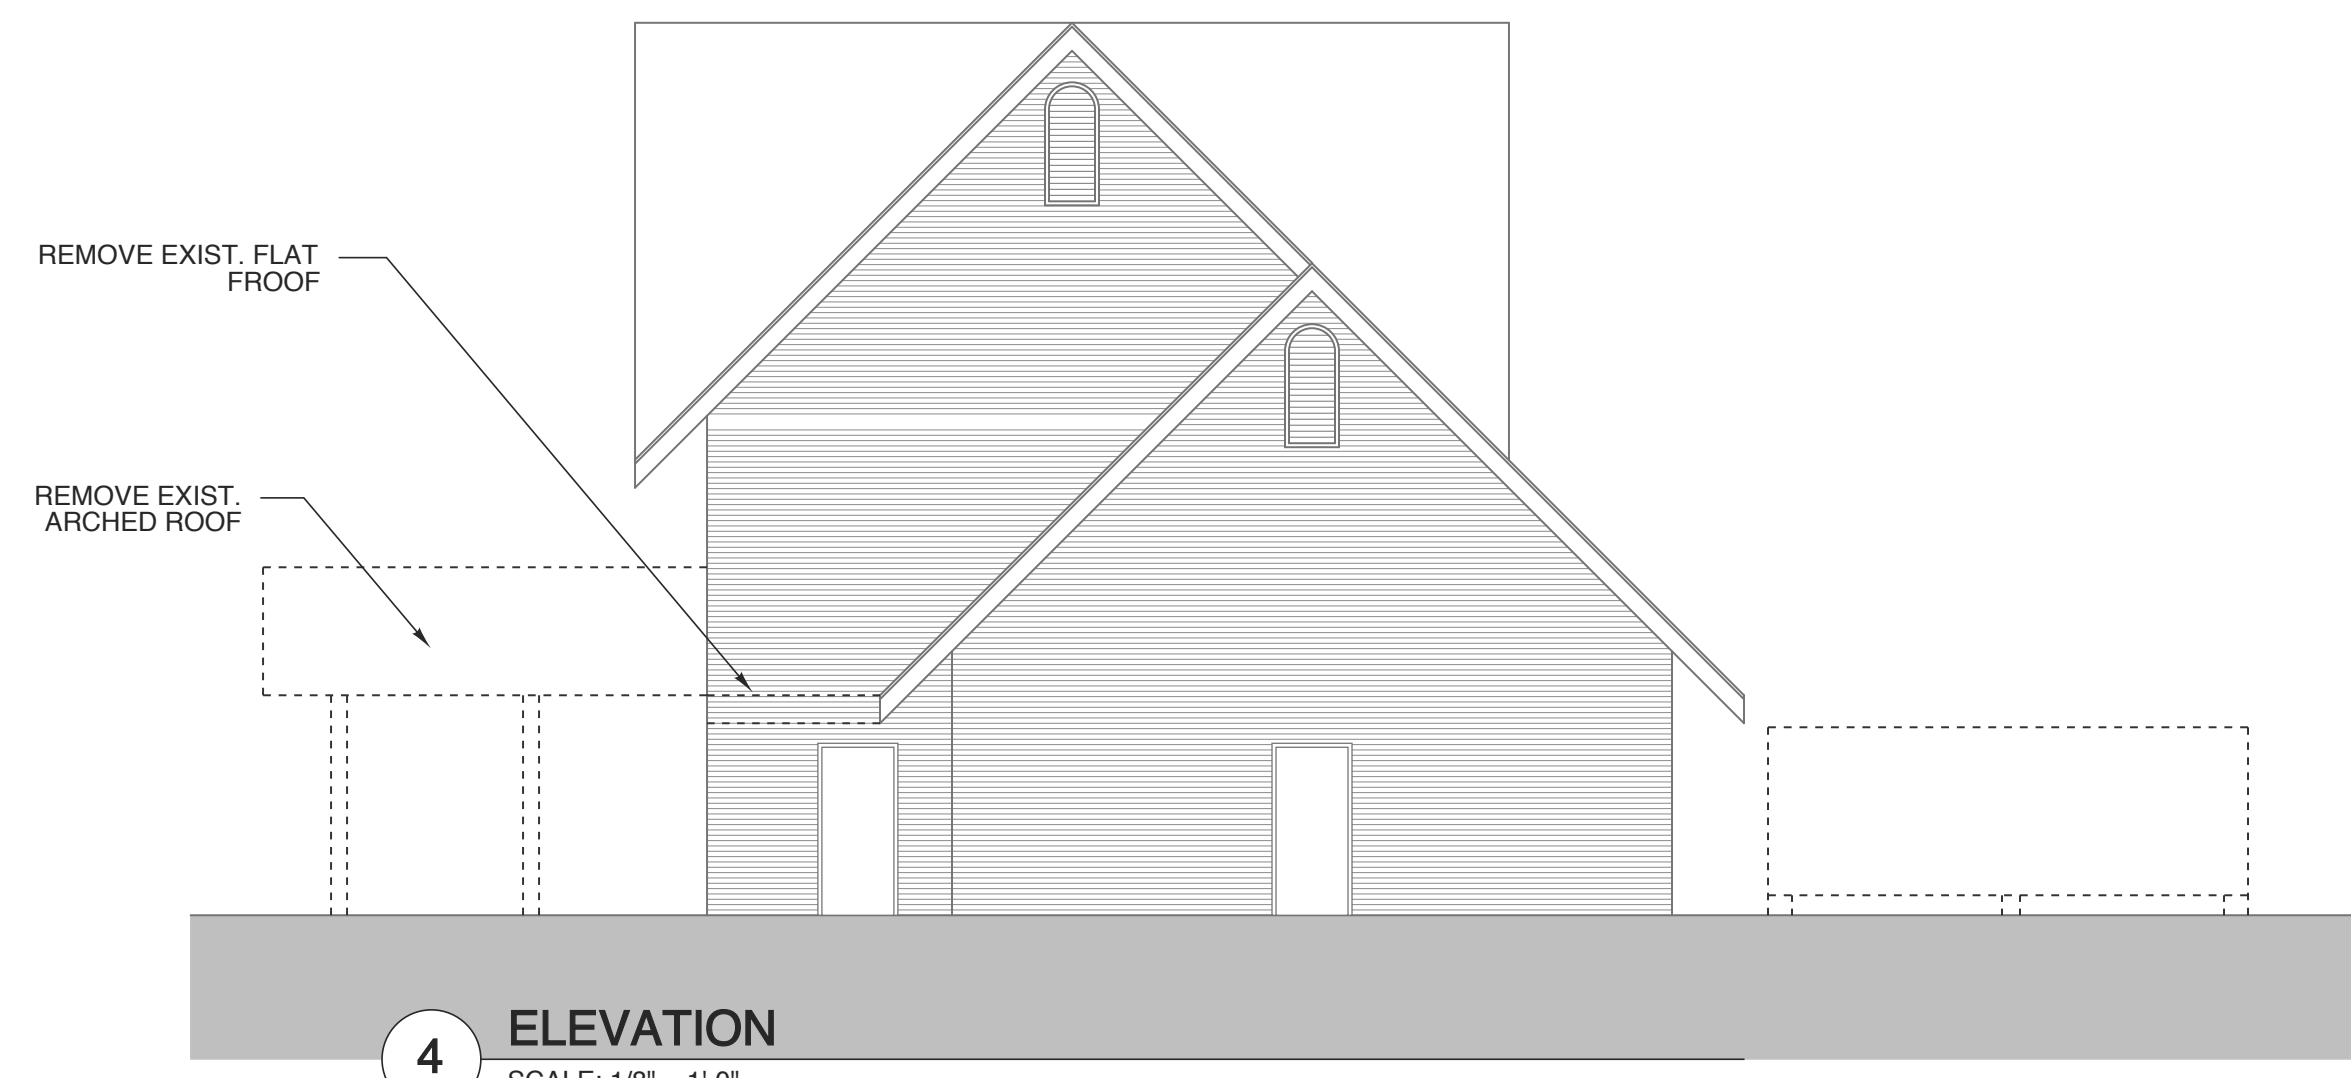
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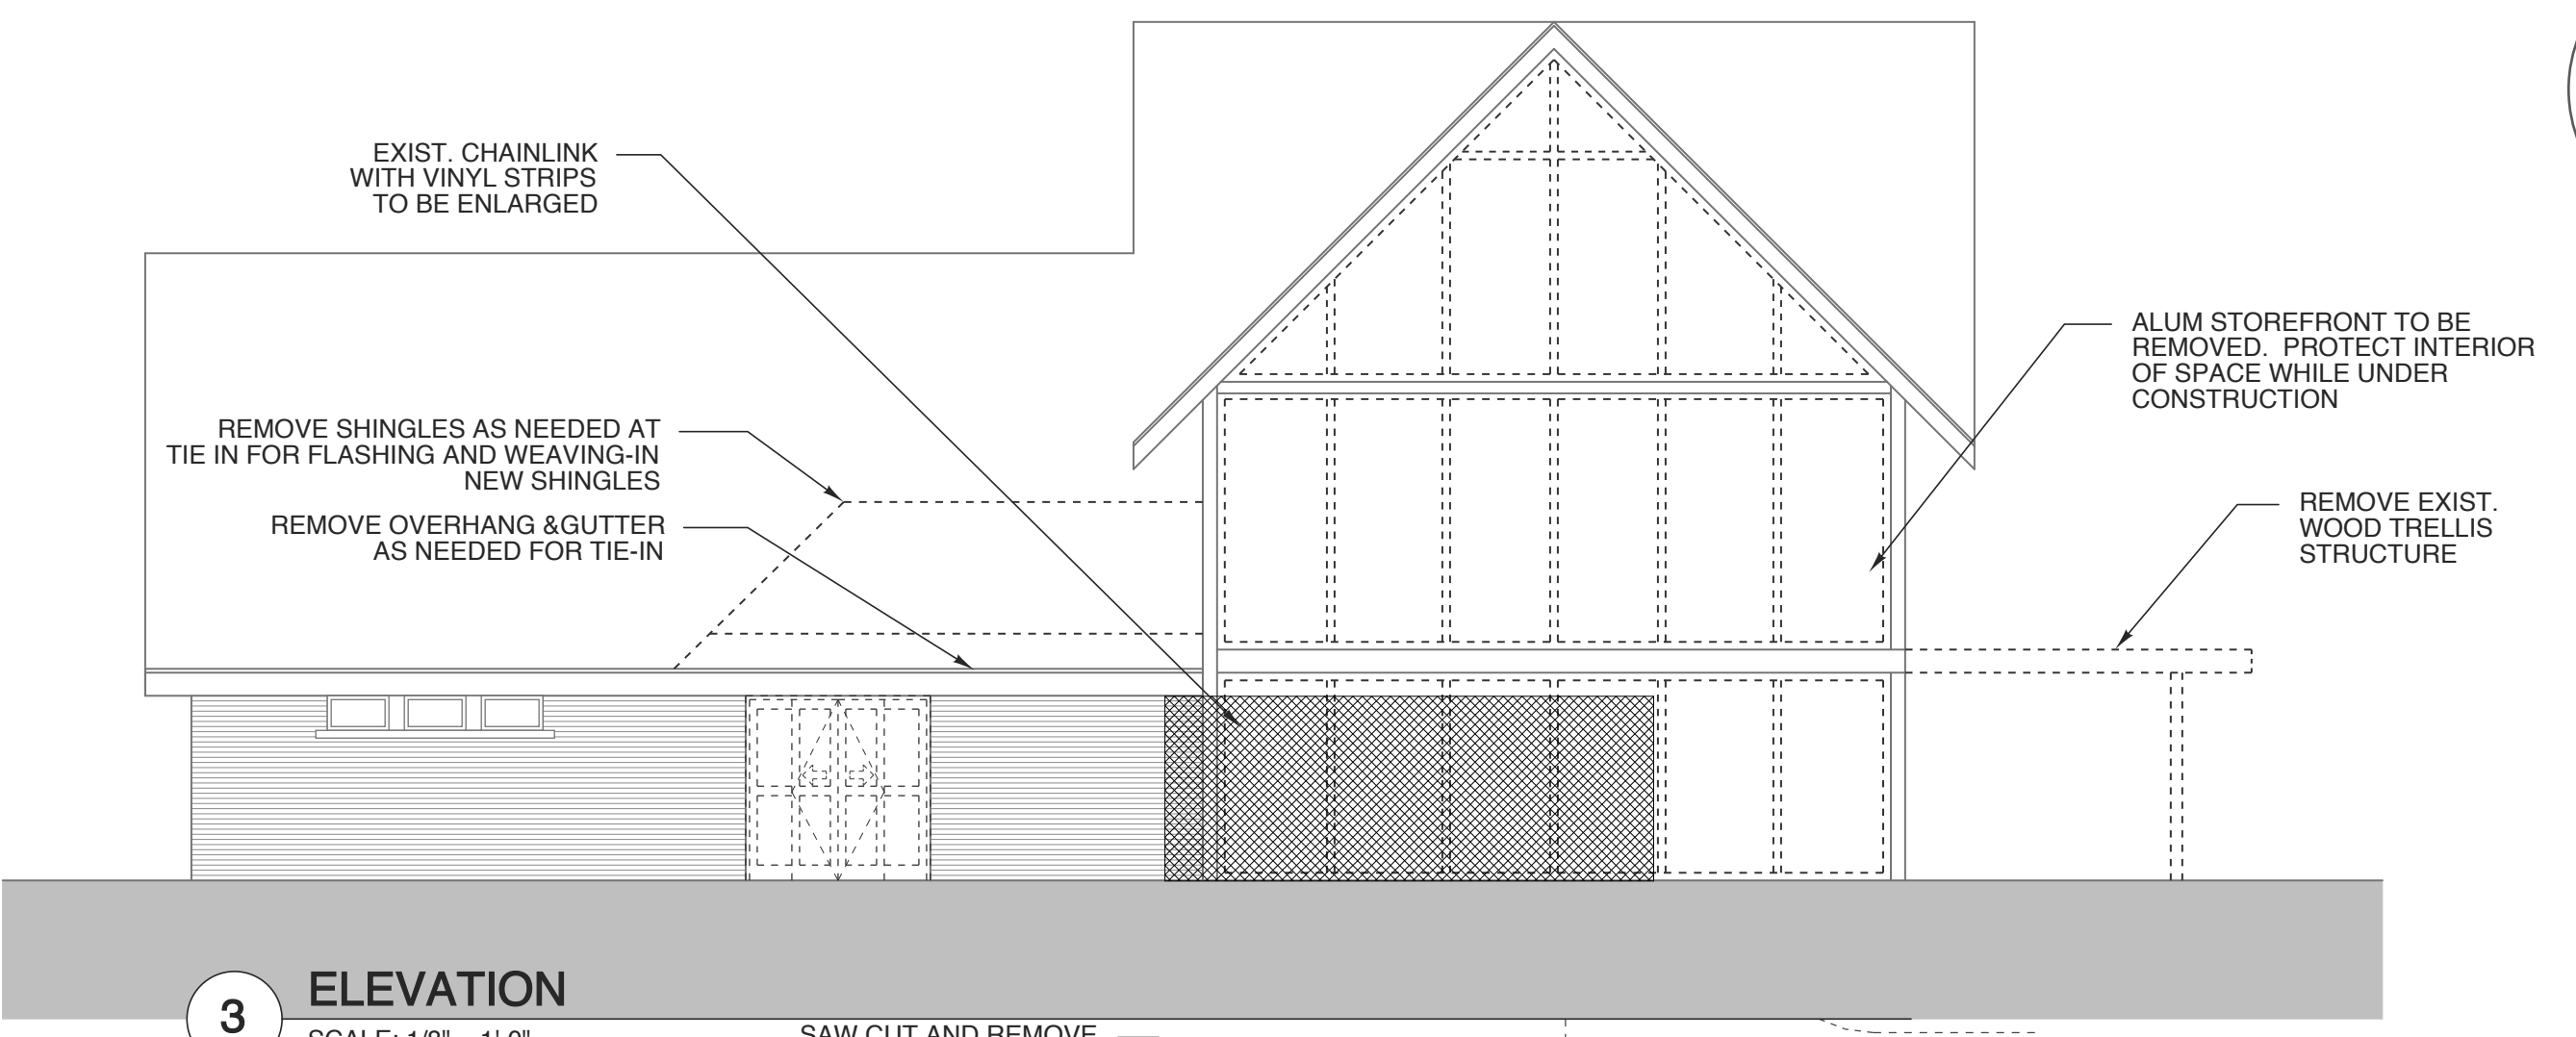
6 ELEVATION
SCALE: 1/8" = 1'-0"

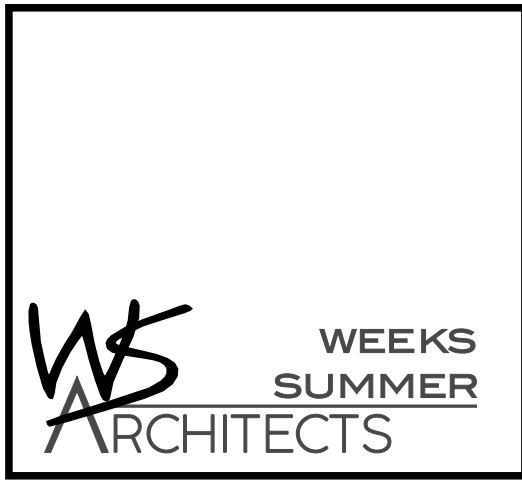

5 ELEVATION
SCALE: 1/8" = 1'-0"

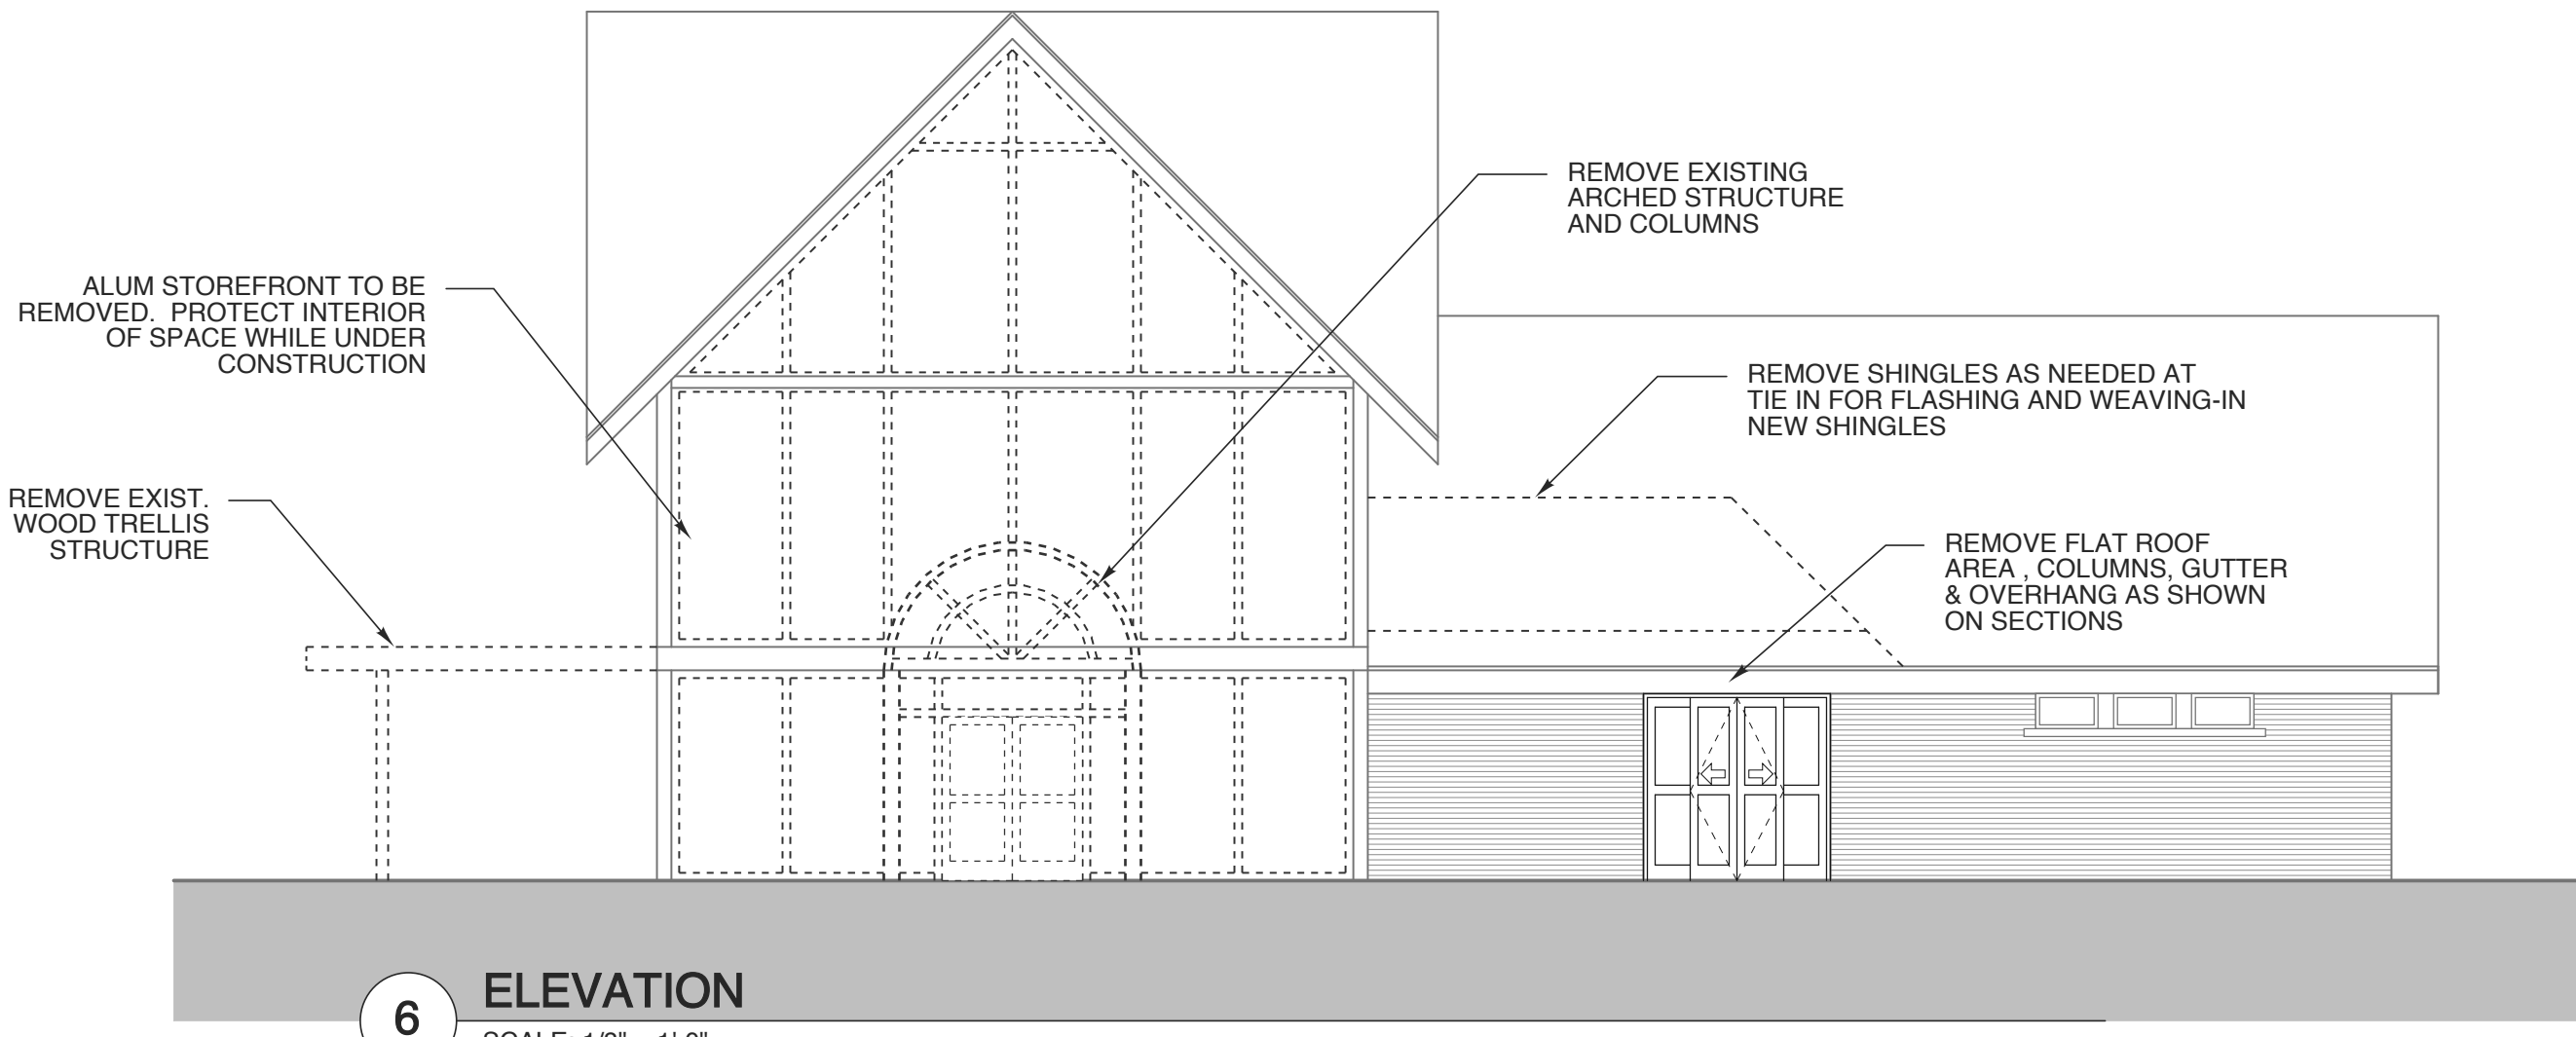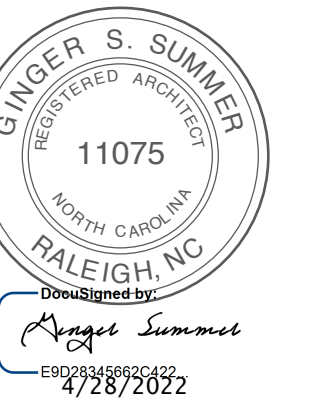

4 ELEVATION
SCALE: 1/8" = 1'-0"



3 ELEVATION
SCALE: 1/8" = 1'-0"

DEMOLITION & CONSTRUCTION NOTES

ALL MATERIALS SHALL BE NEW AND OF QUANTITY SPECIFIED, EXCEPT WHERE RECLAIMED MATERIAL IS INDICATED FOR USE. WORKMANSHIP SHALL AT ALL TIMES BE OF A GRADE ACCEPTED AS THE BEST PRACTICE OF THE PARTICULAR TRADE INVOLVED, AND AS STIPULATED IN WRITTEN STANDARDS OF RECOGNISED ORGANIZATIONS OR INSTITUTES OF THE RESPECTIVE TRADES EXCEPT AS EXCEEDED OR QUALIFIED BY THE SPECIFICATIONS.

ITEMS RESULTING FROM THE DEMOLITION AND ITEMS WHICH ARE NOT TO BE RETURNED TO THE OWNER AS NOTED IN THE CONTRACT DOCUMENTS, SHALL BE REMOVED FROM THE SITE, AS THE WORK PROGRESSES, AND DISPOSED OF IN A LEGAL MANNER.


THE CONTRACTOR SHALL REVIEW EACH PHASE OF THE WORK PRIOR TO PROCEEDING WITH THE WORK AND SHALL NOTIFY THE ARCHITECT IN WRITING OF ANY DISCREPANCIES IN THE CONTRACT DOCUMENTS THAT WILL RESULT IN CHANGES TO THE WORK.

THE EXISTING STRUCTURE SHALL NOT BE ALTERED EXCEPT AS INDICATED IN THE CONTRACT DOCUMENTS. DO NOT CUT, NOTCH, BLOCK OR RELOCATE STRUCTURAL MEMBERS WITHOUT PRIOR APPROVAL OF THE ENGINEER OR ARCHITECT.


AREA OUTSIDE OF AREA OF WORK TO REMAIN CLEAR AND CLEAN OF DEBRIS, EQUIPMENT ETC. AT ALL TIMES.

THE SITE WILL BE CLOSED TO VISITORS WHILE UNDER CONSTRUCTION.

IF CONSTRUCTION REQUIRES AN INTERRUPTION OF SERVICES TO THE BUILDING, THE OWNER AND ARCHITECT SHALL BE NOTIFIED AND AN APPROPRIATE TIMING WILL BE AGREED UPON.

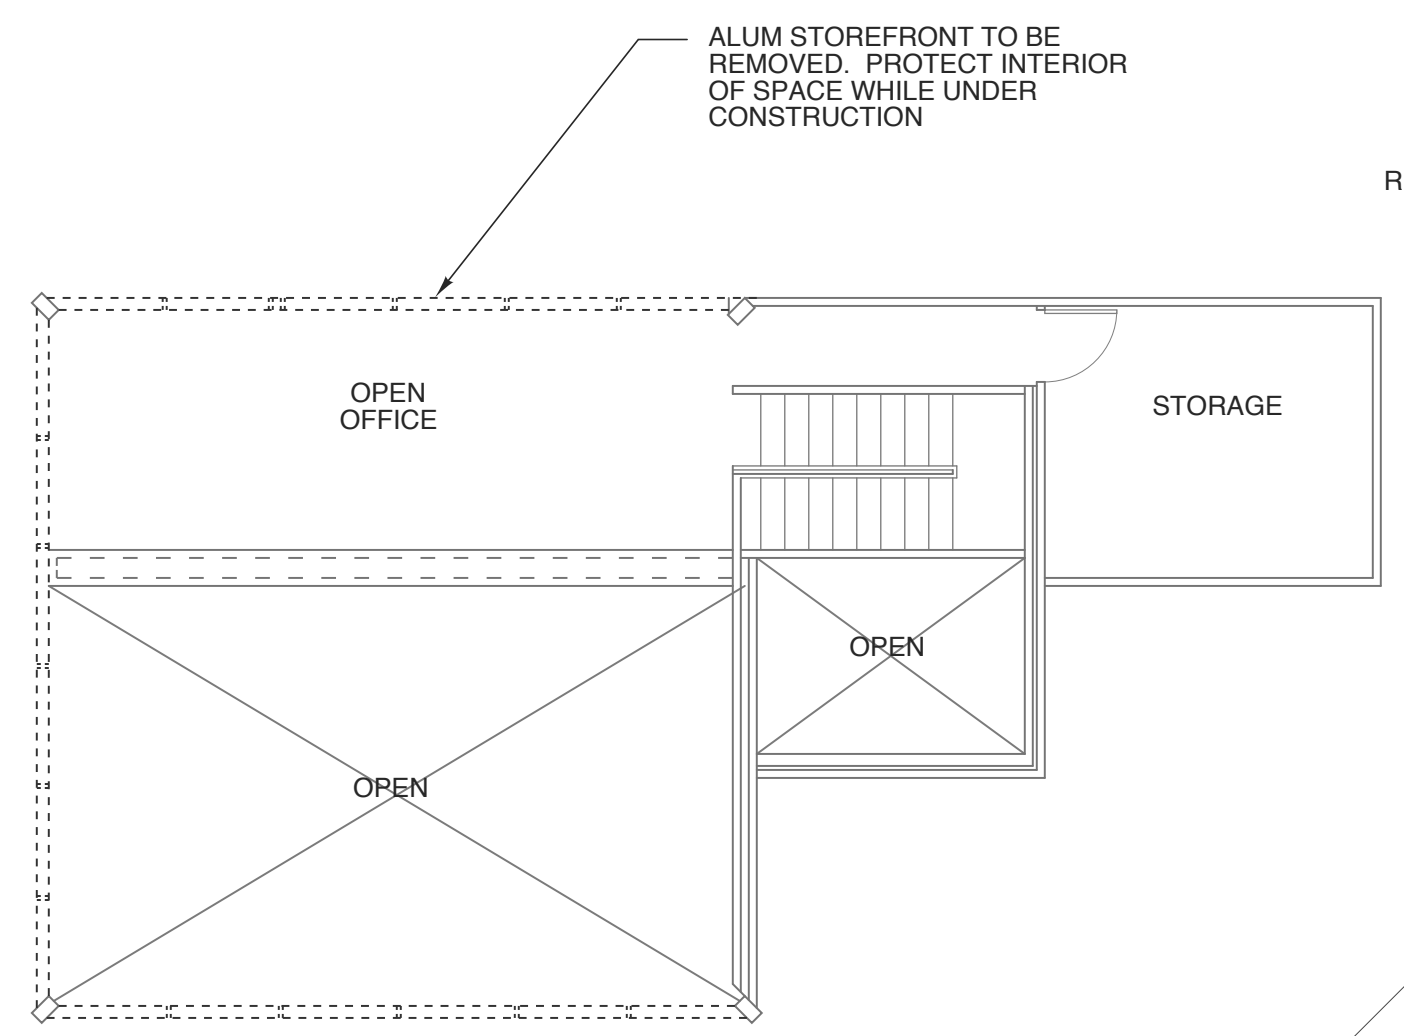

2 2ND FLOOR PLAN
SCALE: 1/8" = 1'-0"

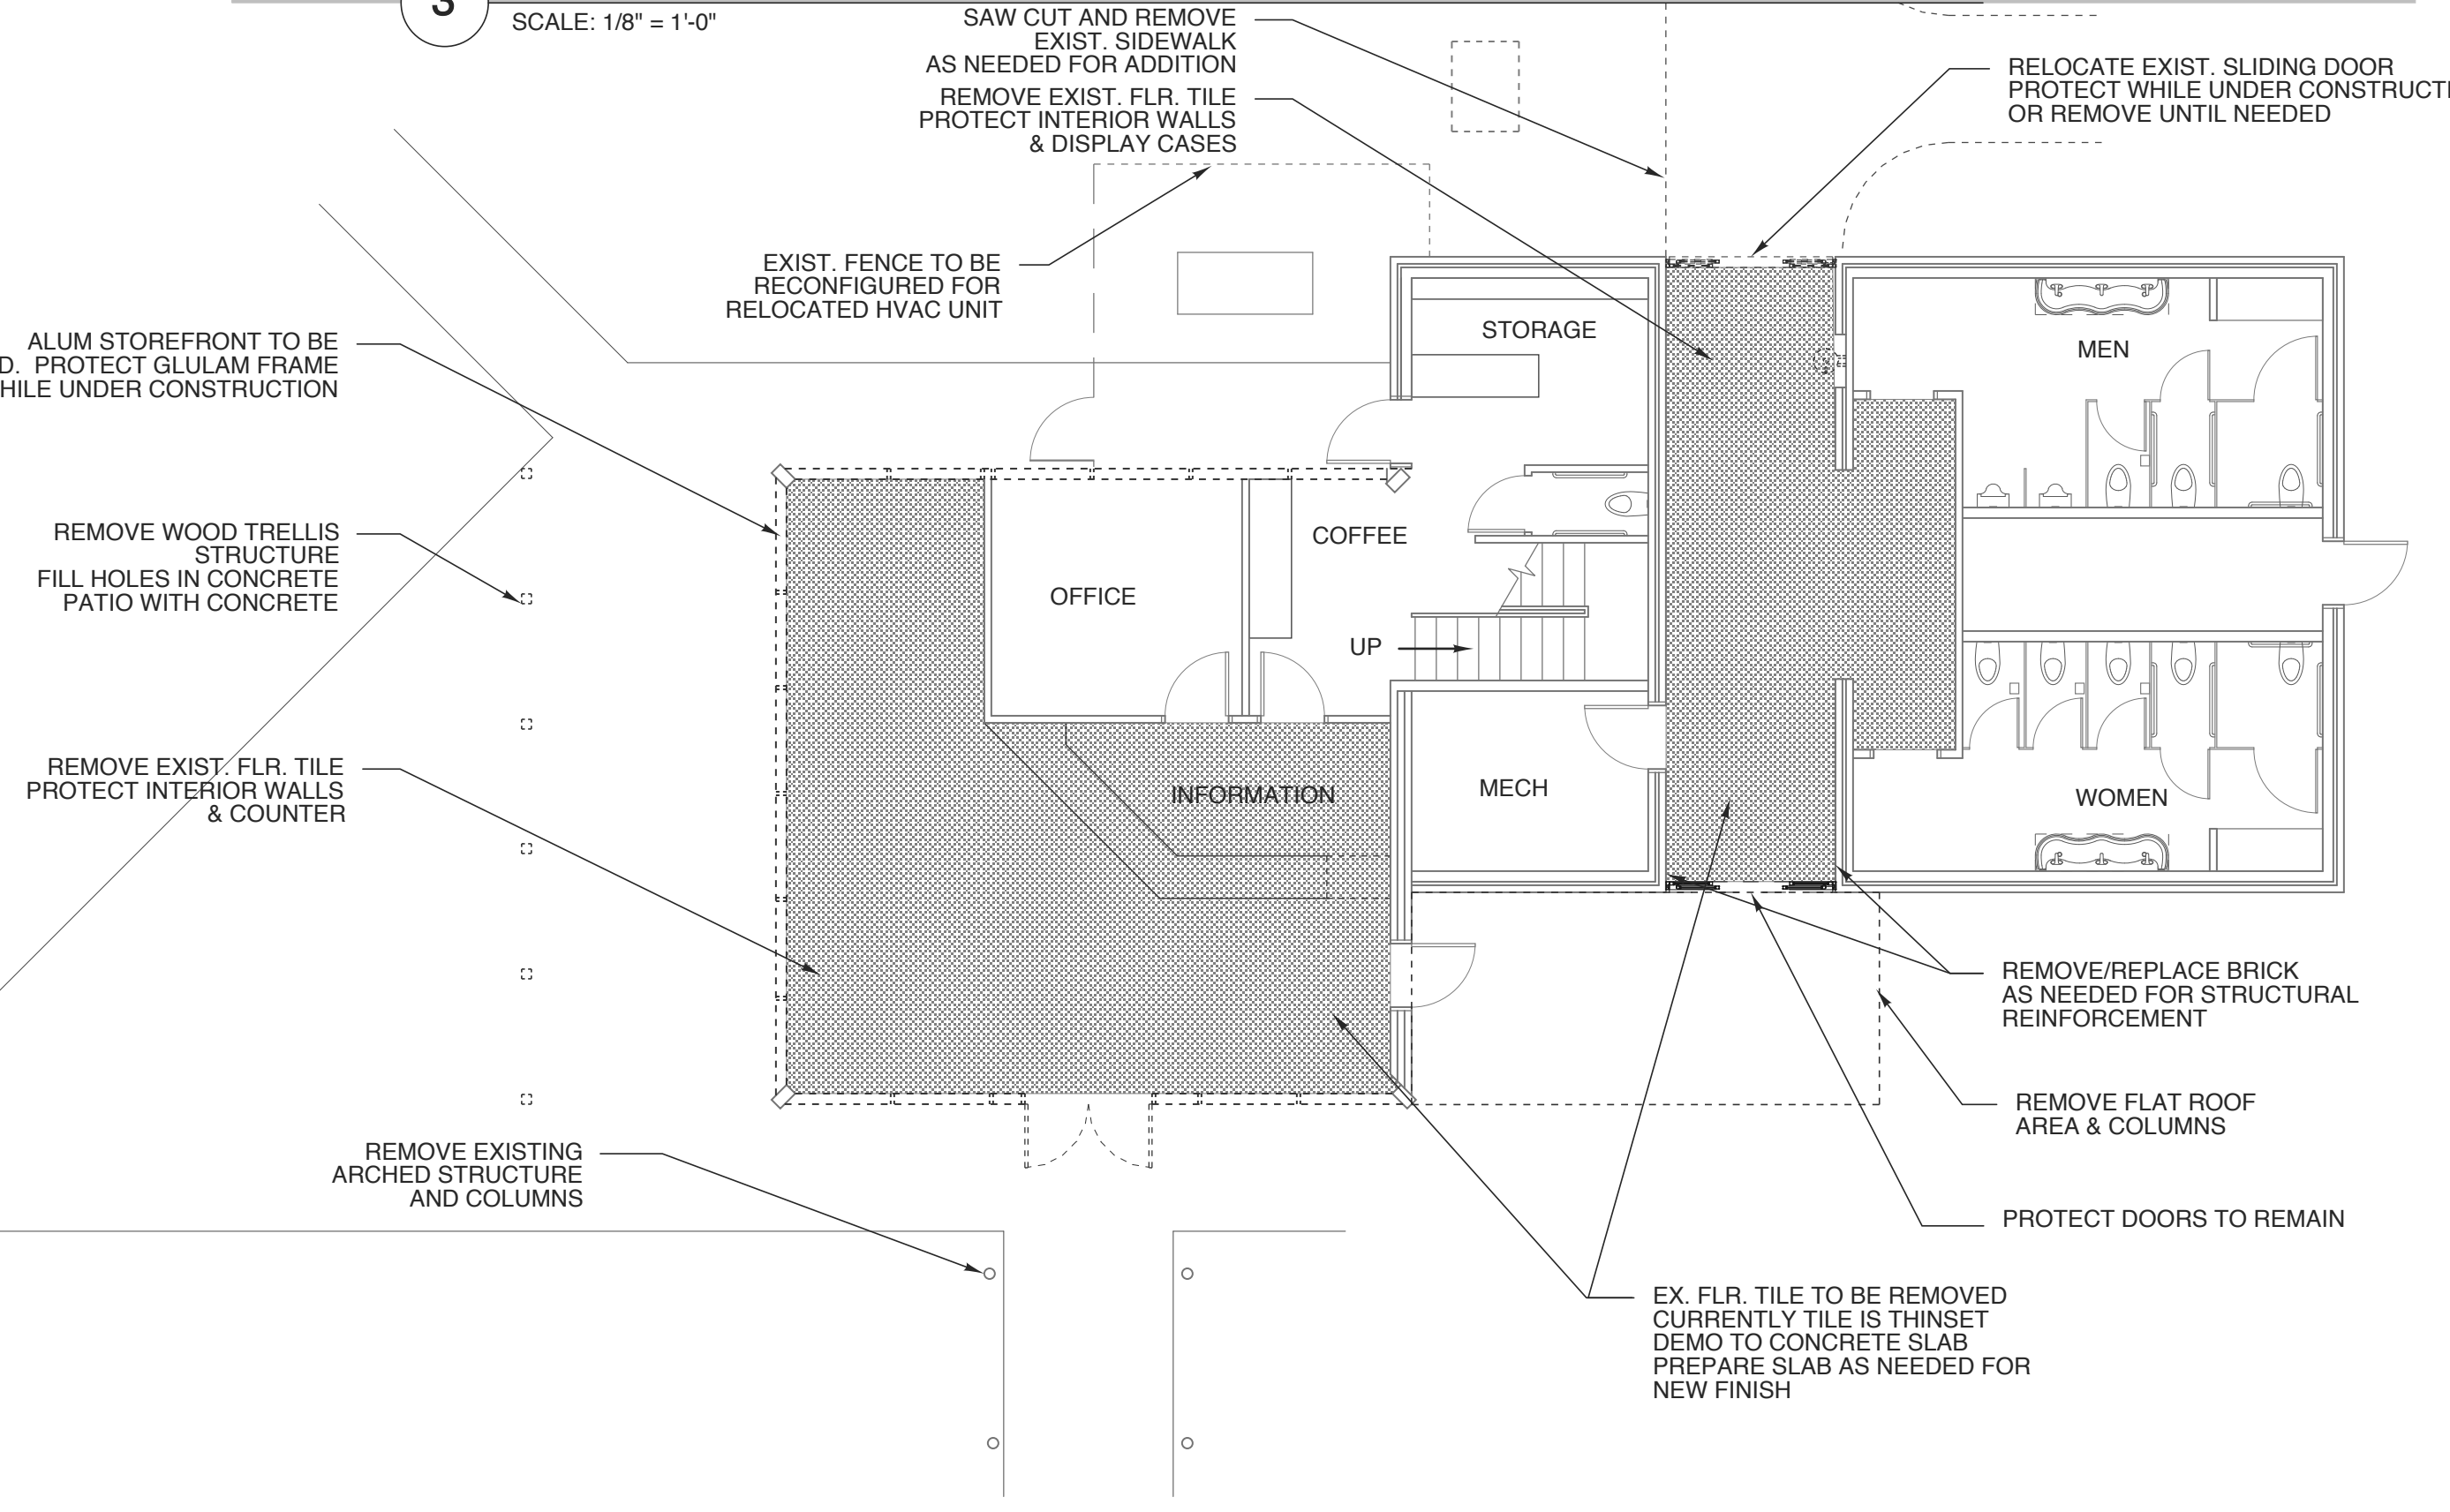

1 1ST FLOOR PLAN
SCALE: 1/8" = 1'-0"

BID SET 4.28.22
WBS: 15RE.13.3
SCO ID# 21-24079-01A

PROJECT TITLE
BRUNSWICK CTY VISTOR'S CENTER
394 WHITEVILLE ROAD NW
SHALLOTE, NORTH CAROLINA


PROJECT NO.
2104a
DRAWING TITLE
DEMO PLAN & ELEV

SHEET **3** OF **12**

A1.1

PLOT DATE
REVISION **00/00/14**


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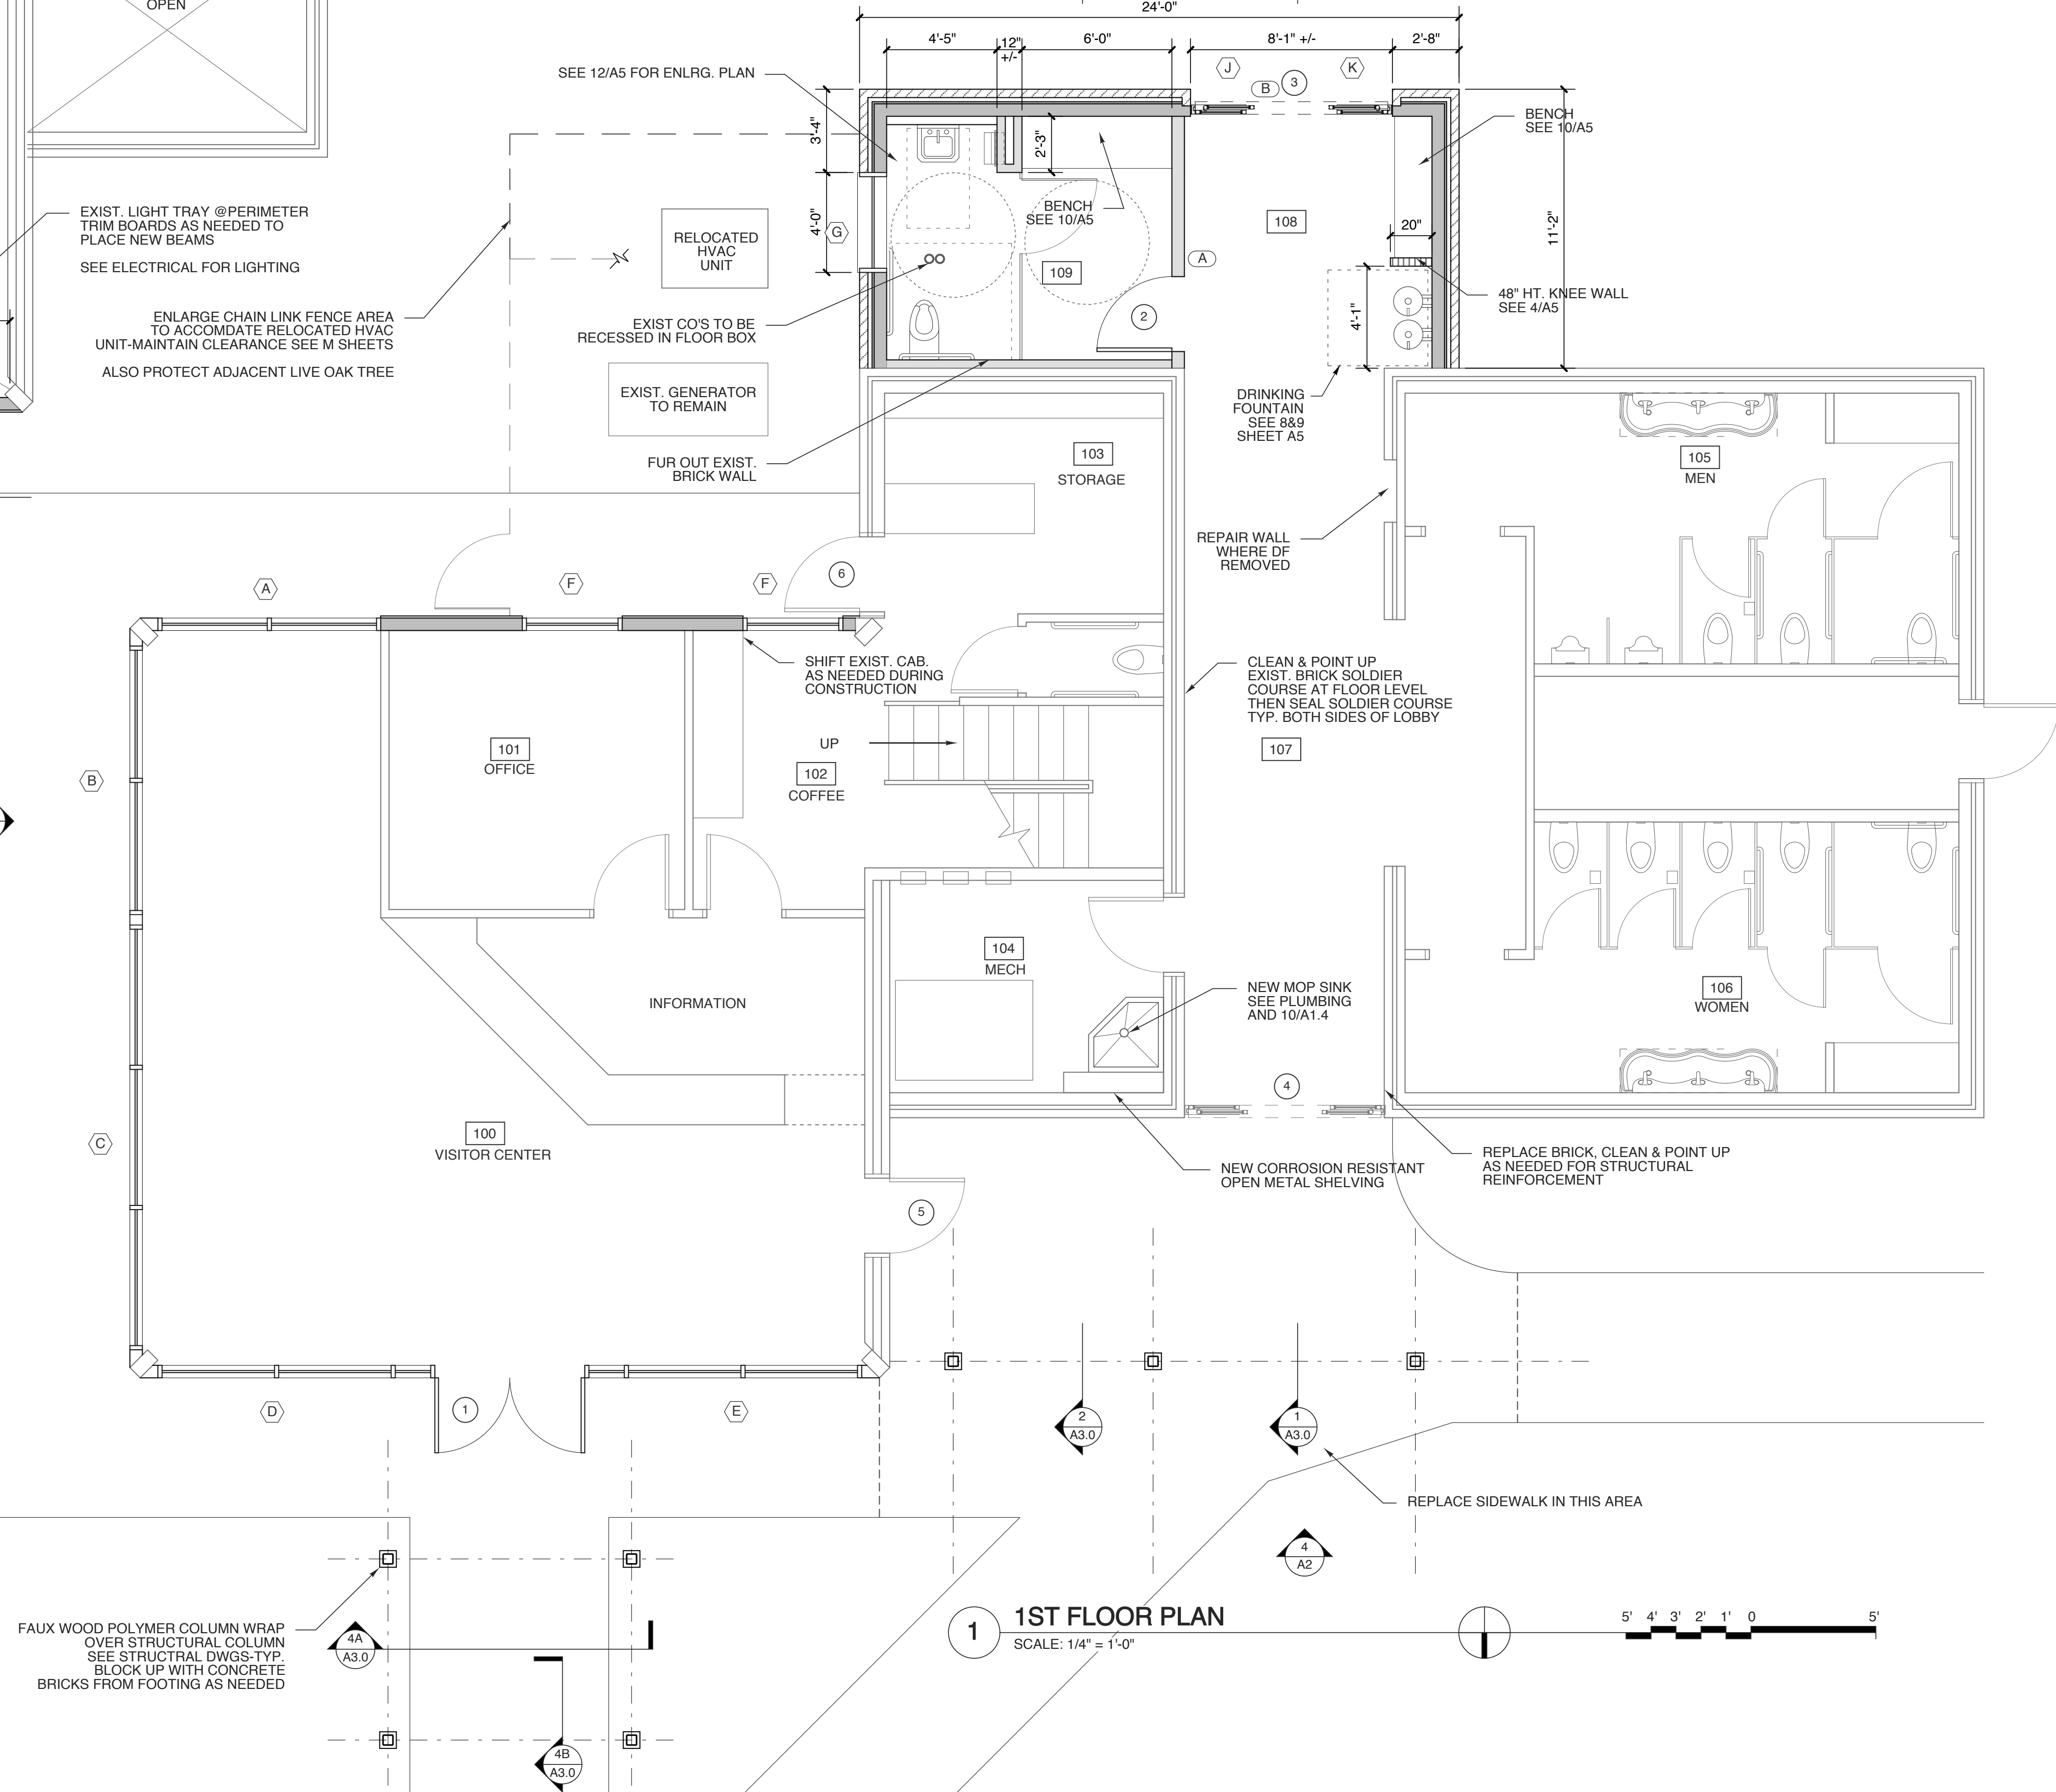
2 2ND FLOOR PLAN
SCALE: 1/4" = 1'-0"

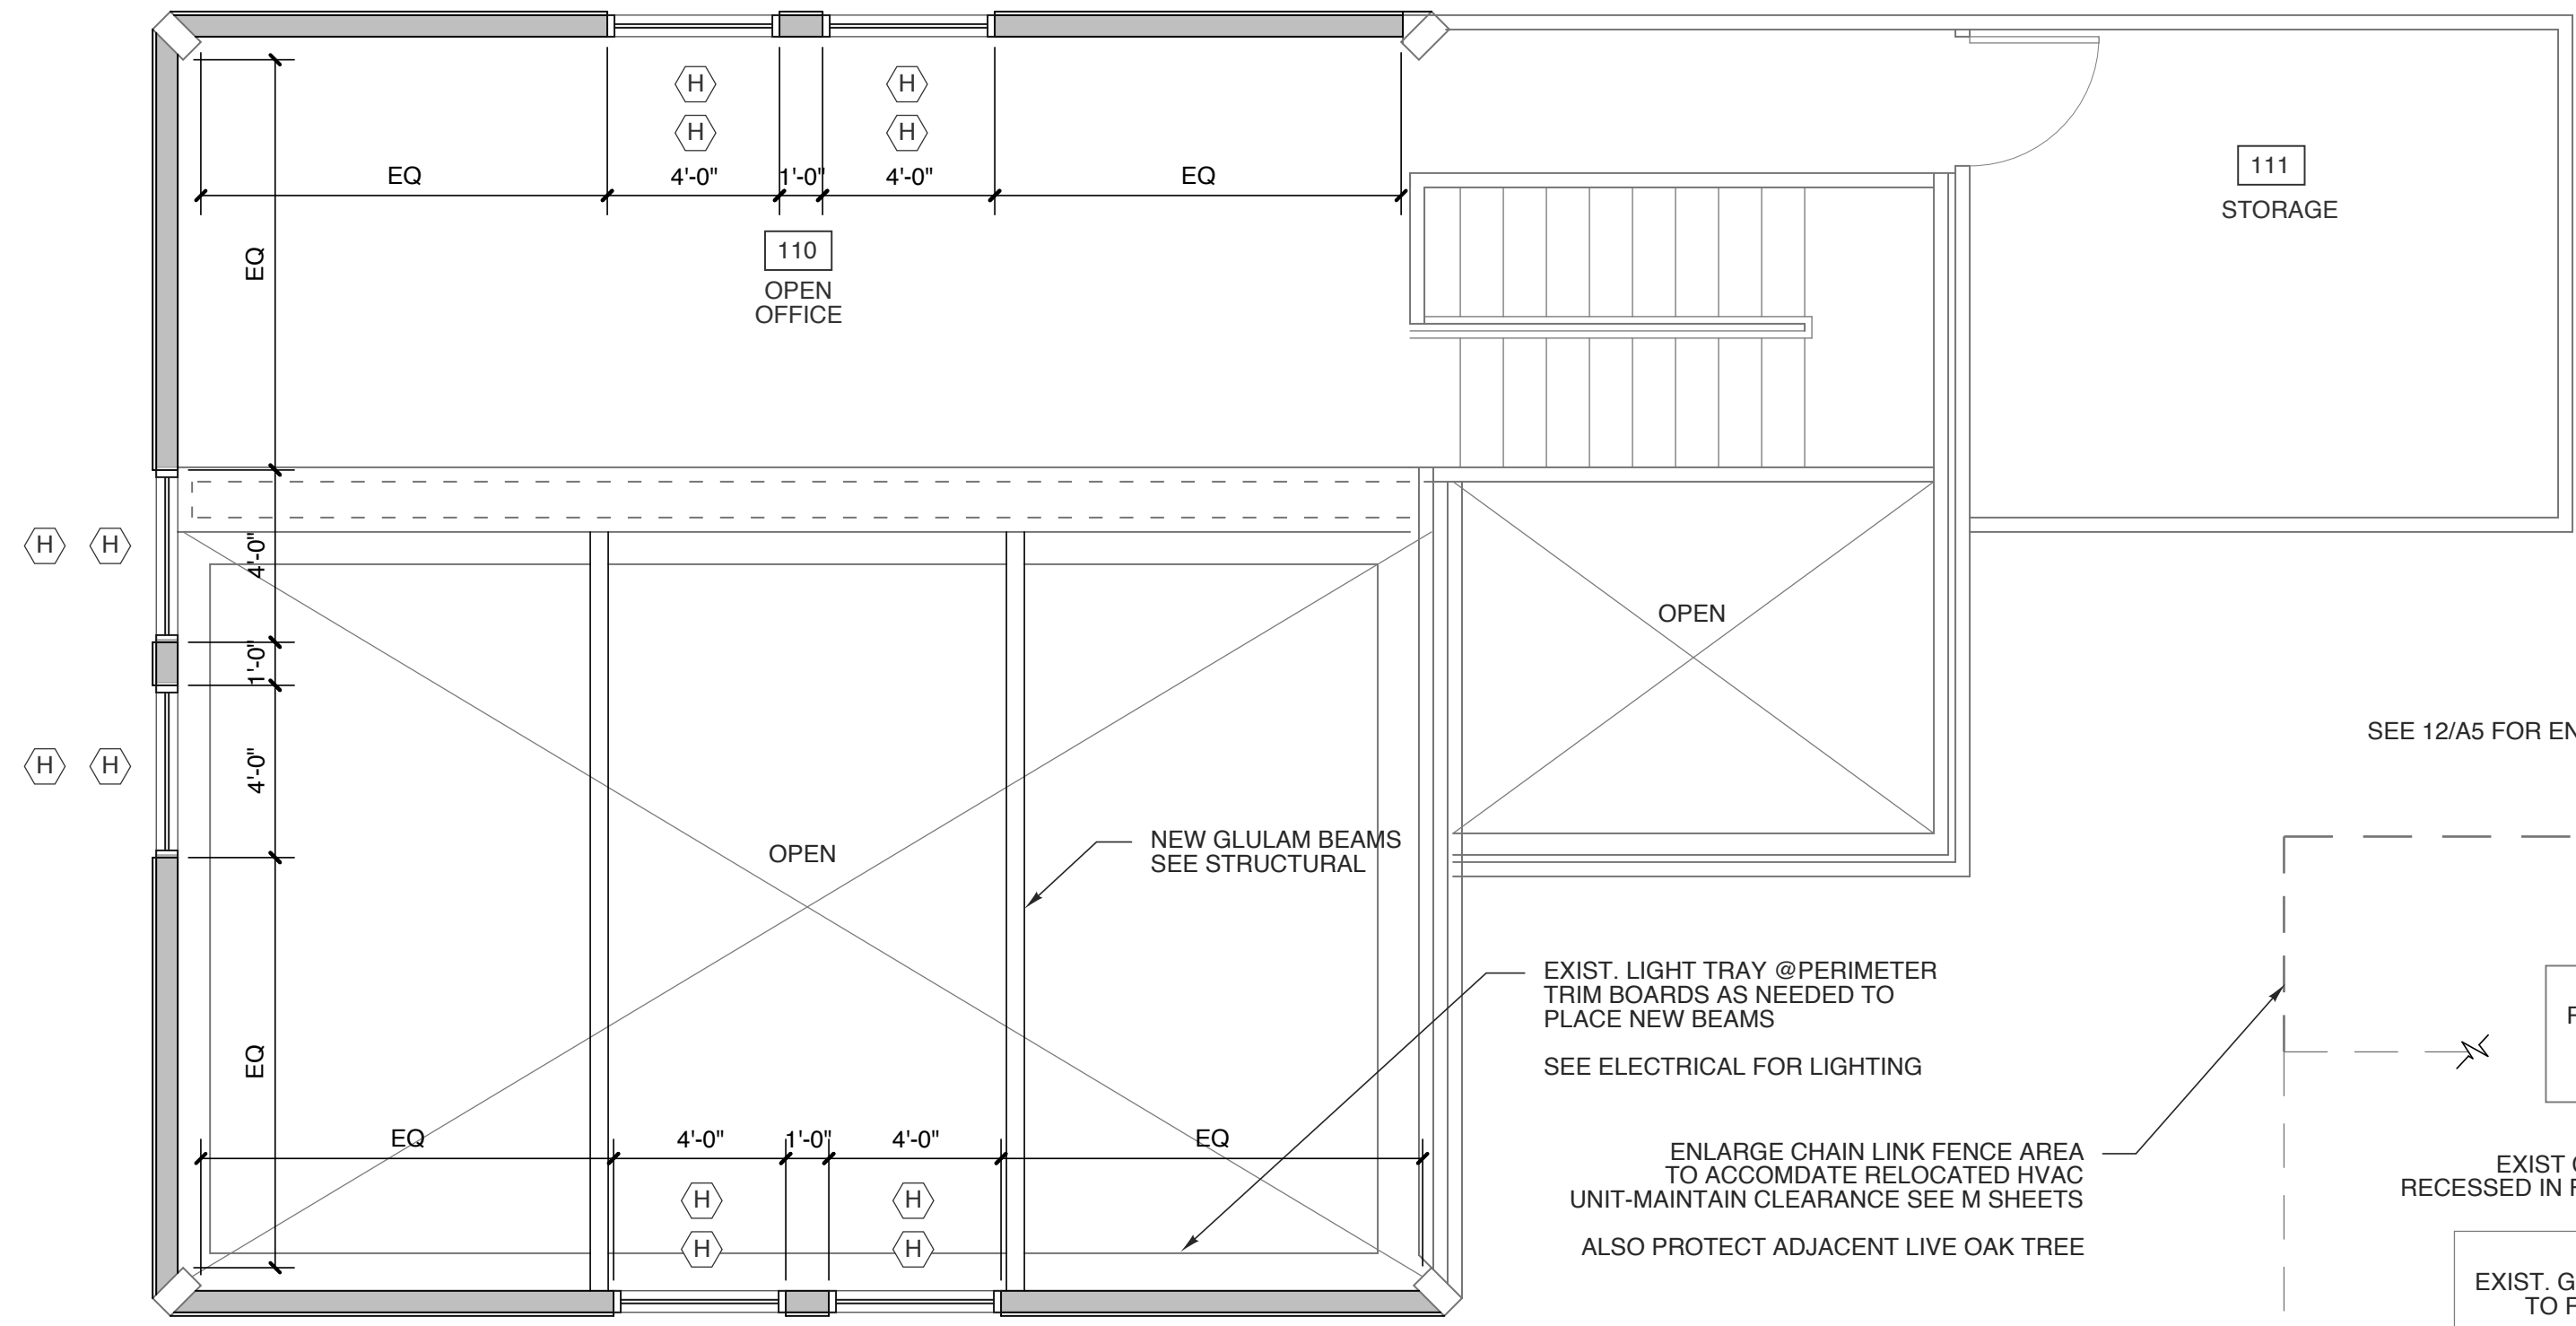SIGNAGE LEGEND	
(A)	FAMILY-1 PC. MILLED ALUM PER 6/A5
(B)	RESTROOM-INDIVIDUAL LETTERS 5/A5 (8")

- NOTES**
1. CONTRACTOR TO SUPPLY ALL BLOCKING NEEDED TO SUPPORT REQUIRED RESTROOM ITEMS UNLESS OTHERWISE NOTED OR STATED PER MANF.
 2. VERIFY ALL ROUGH OPENING DIMENSIONS WITH MANUFACTURERS REQUIREMENTS
 3. SEE SHEETS A4.1 FOR MORE REQ. CLEARANCES
 4. SEE SHEETS A4.2 FOR INTERIOR ELEVATIONS
 5. SEE ELECTRICAL AND MECHANICAL DRAWINGS FOR EQUIPMENT LOCATIONS.
 6. SEE DETAIL 10/A4.1 FOR TILE LEGEND OF INTERIOR ELEVATIONS



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1 1ST FLOOR PLAN
SCALE: 1/4" = 1'-0"

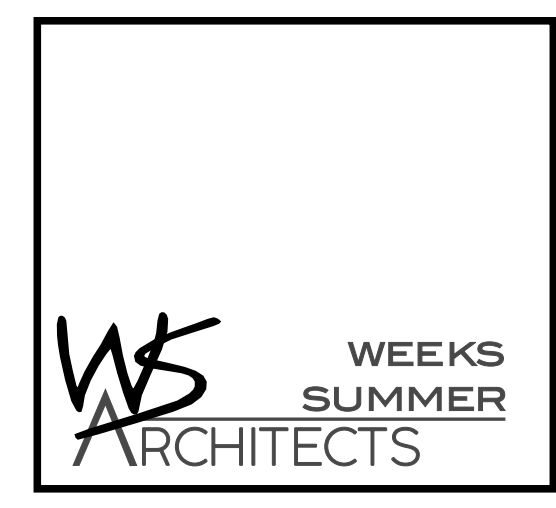WALL LEGEND	
	EXIST. BRICK VENEER WALL TO REMAIN
	EXIST. INTERIOR WALL TO REMAIN
	NEW BRICK VENEER WALL
	NEW INTERIOR WALL
	NEW EXTERIOR WALL W/ COMP. SIDING

BID SET 4.28.22
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SCO ID# 21-24079-01A

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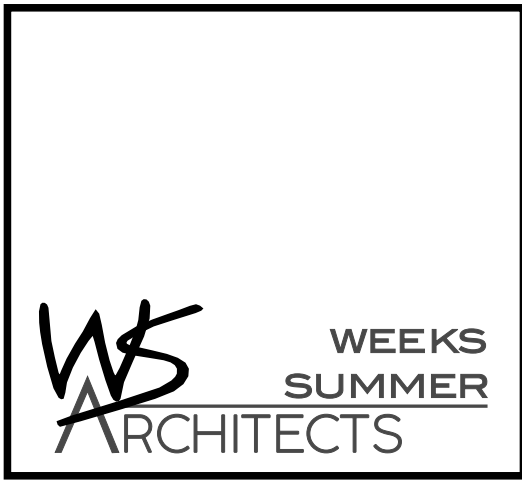
PROJECT NO.
2104a
DRAWING TITLE
FLOOR PLAN

SHEET **4** OF **12**



A1.2

PLOT DATE **4/28/22**
REVISION **00/00/00**


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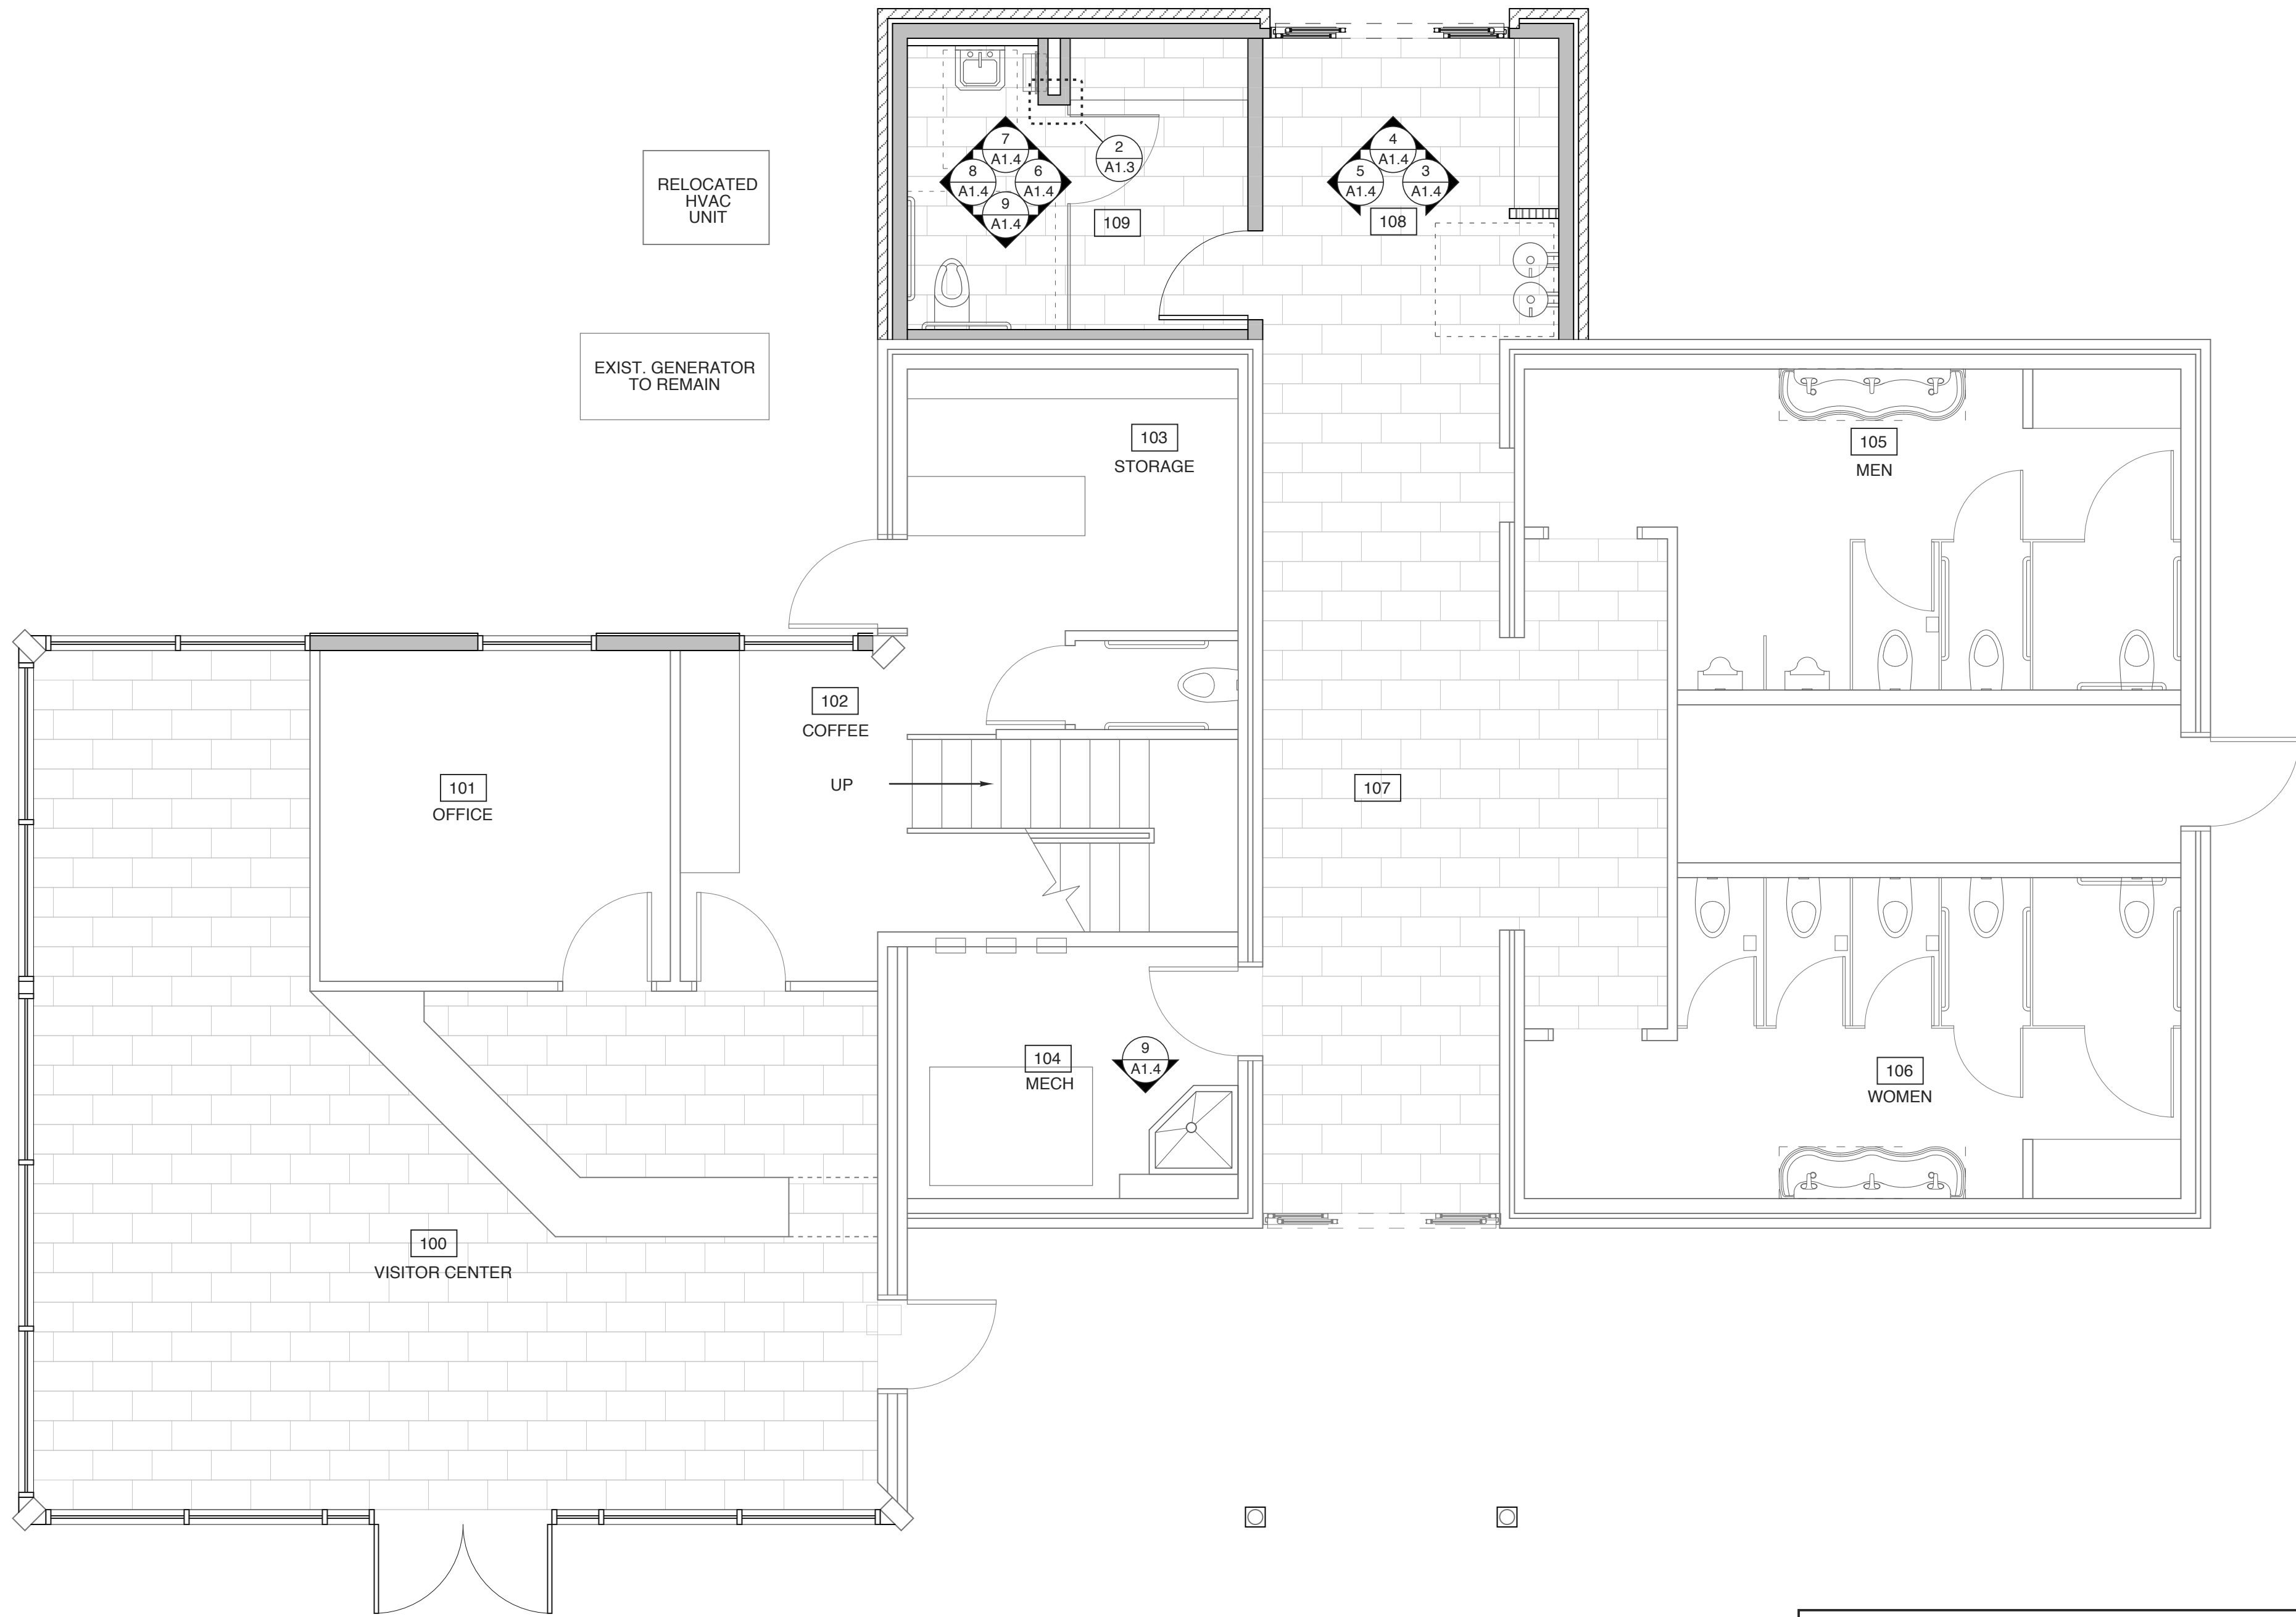
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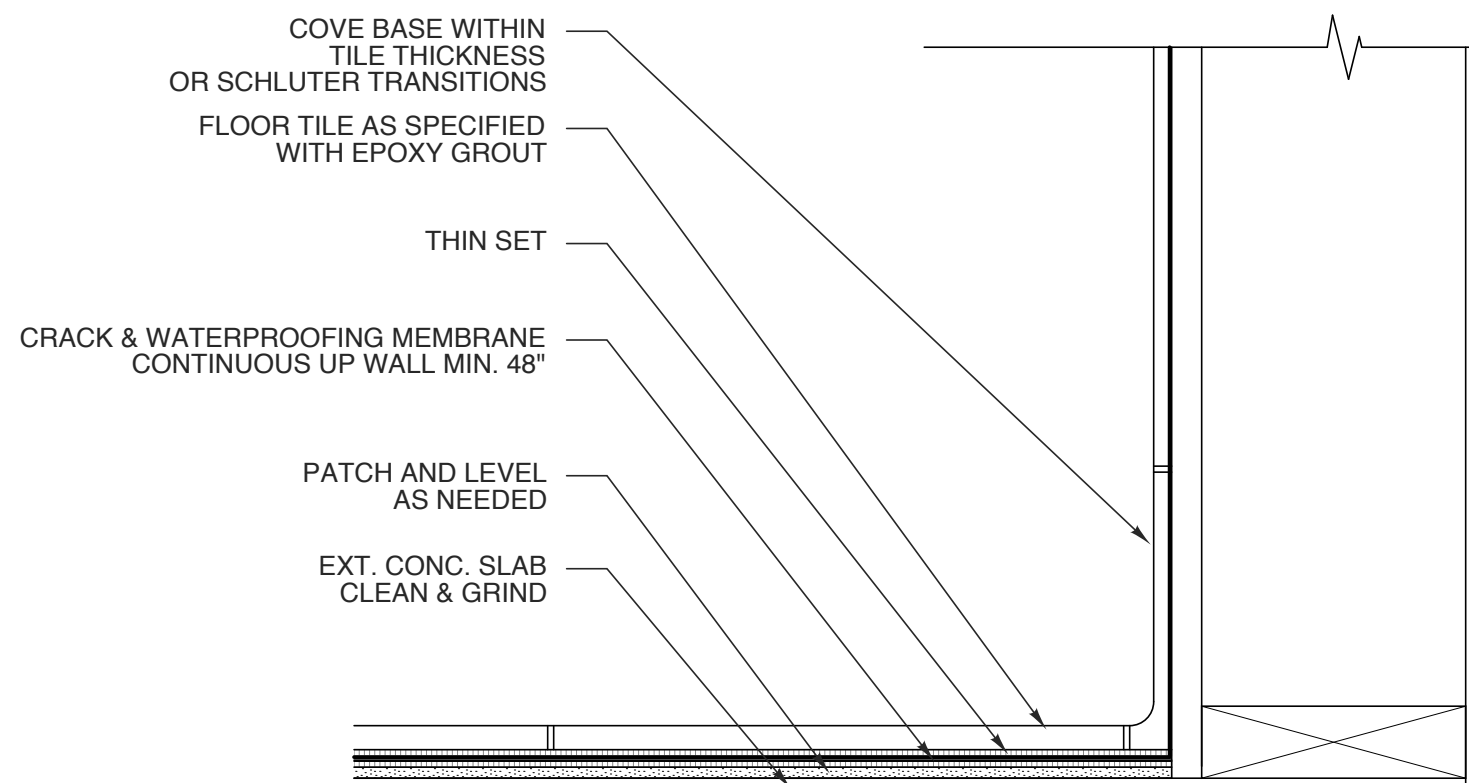
5 DISPLAY DETAIL
SCALE: 1 1/2" = 1'-0"




4 SLAB REPAIR/PREP
SCALE: NTS

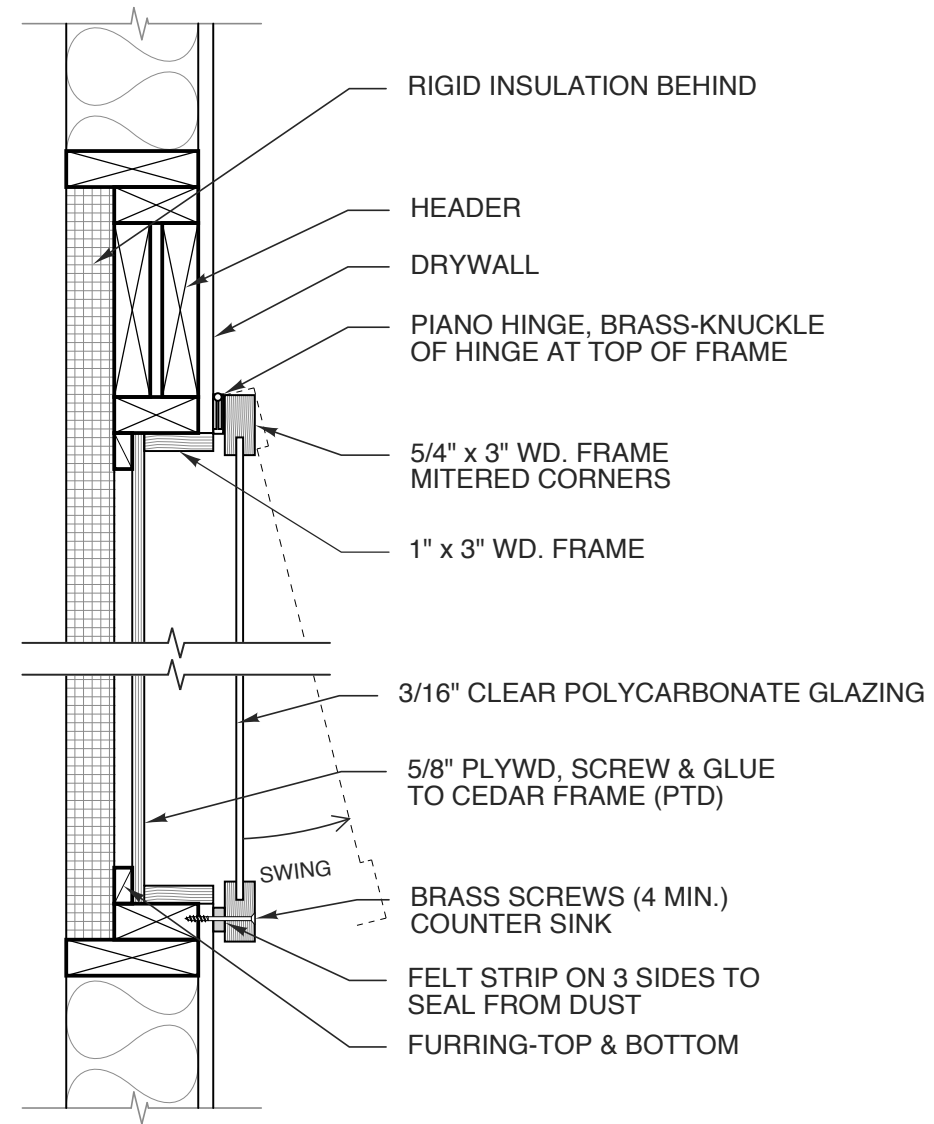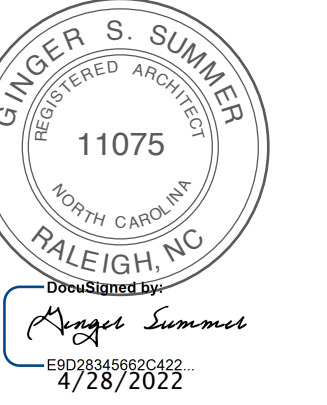

1 FINISH PLAN
SCALE: 1/4" = 1'-0"

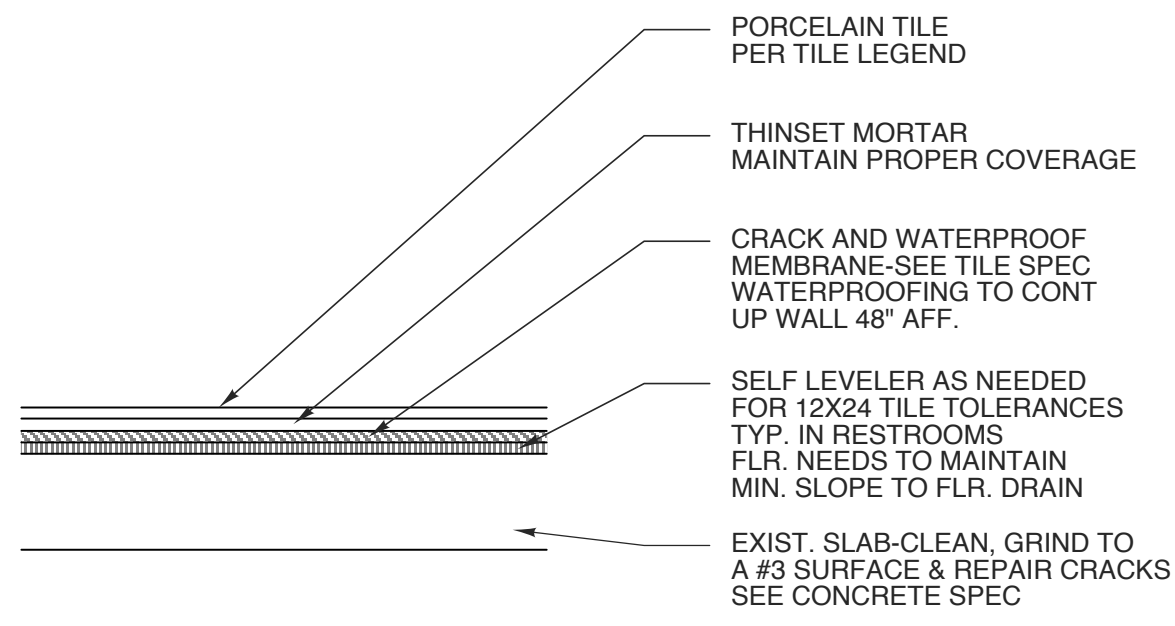

3 FLOOR TILE DETAIL
SCALE: 3" = 1'-0"

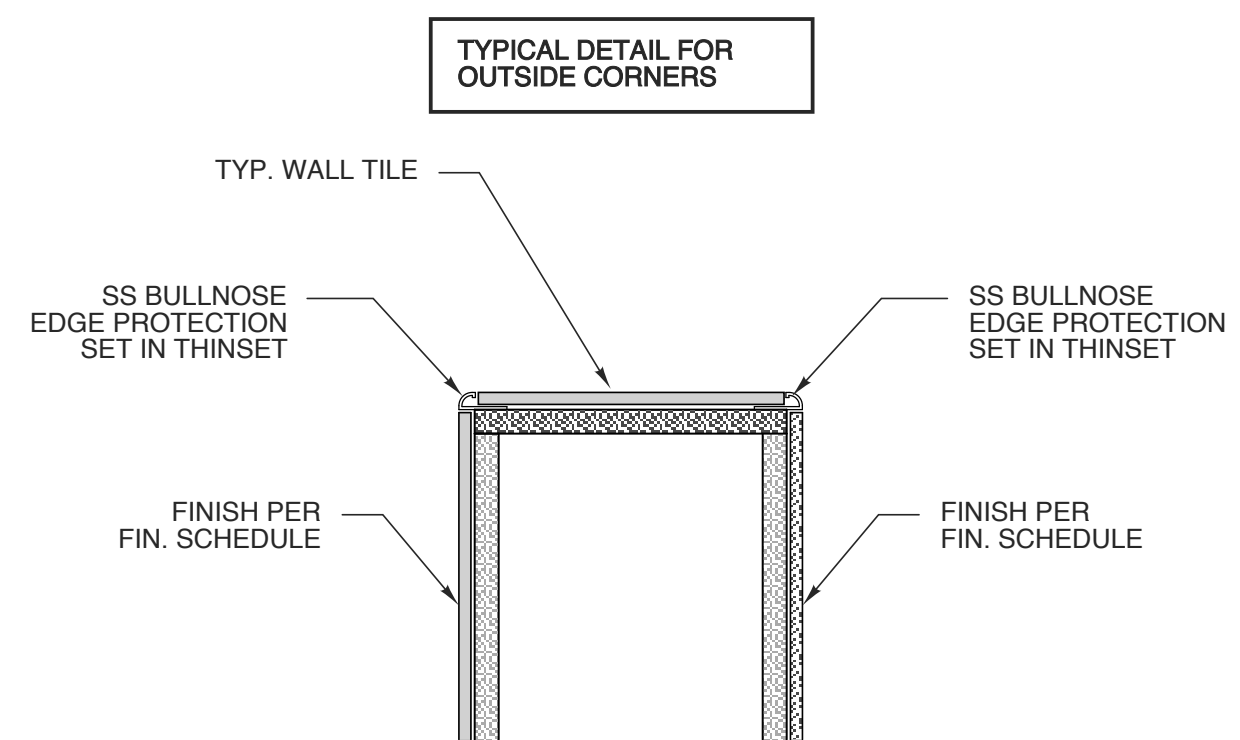

2 OUTSIDE CORNER/END WALL
SCALE: NTS

MARK	ROOM NAME	FLOOR	BASE	WALL				WAINSCOT	CEILING MATERIAL	REMARKS / NOTES
				N	E	S	W			
100	VISITOR CENTER	POR. TILE	POR. TILE	PAINT EXIST. & NEW					exist.	---
101	OFFICE	exist.	exist.	PAINT NEW WALLS					exist.	---
102	COFFEE	exist.	exist.	PAINT NEW WALLS					exist.	---
103	STORAGE	exist.	exist.						exist.	---
104	MECHANICAL	exist.	exist.						exist.	---
105	MEN	exist.	exist.	PAINT EXIST.					exist.	---
106	WOMEN	exist.	exist.	PAINT EXIST.					exist.	---
107	EXIST. LOBBY	POR. TILE	POR. TILE	CLEAN EXIST. BRICK				PAINT EXIST. PATCH AS NEEDED		PAINT AT ENTRY TO RESTROOMS
108	NEW LOBBY	POR. TILE	POR. TILE	PAINT NEW			48" HT. POR. TILE	PTD. DRYWALL		SCHULTER RONDEC TRIM AT TOP OF WAINSCOT
109	FAMILY ROOM	POR. TILE	POR. TILE	WALL TILE				PTD. DRYWALL		---
110	OPEN OFFICE	exist.	exist.	PAINT NEW				exist.		---
111	UPSTAIRS STORAGE	exist.	exist.					exist.		---

TILE LEGEND

FLOOR A (1st CHOICE)
BEST TILE: STAX, TAUPE, 12 X 24
IN LIEU OF TILE COVE BASE USE SCHULTER DILEX-EHK & RONDEC WITH HALF FLOOR TILE FOR 6" BASE
EPOXY GROUT (LATICRETE-24 NATURAL GREY)

FLOOR B (ALTERNATE IF 'A' UNAVAILABLE)
CAESAR, ORIGIN, DESERT, 12 X 24
MATCHING COVE BASE
EPOXY GROUT (LATICRETE-27 HEMP)

TYP. WALL
BRIXTON, IVORY, 4X16, GLOSSY CERAMIC
VERTICAL ORIENTATION
GROUT SAME AS FLOOR GROUT COLOR

WAINSCOT
WITH FLOOR 'A' ATERRA TOBACCO 8X48
EPOXY GROUT (LATICRETE 35 MOCHA)
WITH FLOOR 'B' ATERRA JUTA 8X48
EPOXY GROUT (LATICRETE 56 DESERT KHAKI)

- TILE NOTES**
- WALL TILE TO BE APPLIED TO CEMENT BOARD AS RECOMMENDED BY MANUFACTURER
 - GROUT JOINTS TO BE 1/8".
 - ALL GROUT TO BE EPOXY. CLEAN RESIDUE IN SMALL AREAS CLEAN SUCH THAT NO HAZE TO REMAIN.
 - CAULK ALL INSIDE CORNERS AT TILE
 - MAINTAIN EXIST. CONTROL JTS. IN TILE.
 - STAGGER TILE PATTERN AT 1/3 TILE LENGTH.
 - PLAN LAYOUT TO MINIMIZE TILES LESS THAN 1" LAYOUT ON PLAN FOR REFERENCE ONLY
 - LIPPAGE TOLERANCE IS 1/32". KEEP TO MINIMUM.

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PROJECT TITLE
BRUNSWICK CTY VISTOR'S CENTER
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SHALLOTE, NORTH CAROLINA


PROJECT NO.
2104a
DRAWING TITLE
FINISH PLAN

SHEET 5 OF 12


A1.3

PLOT DATE 4/28/22
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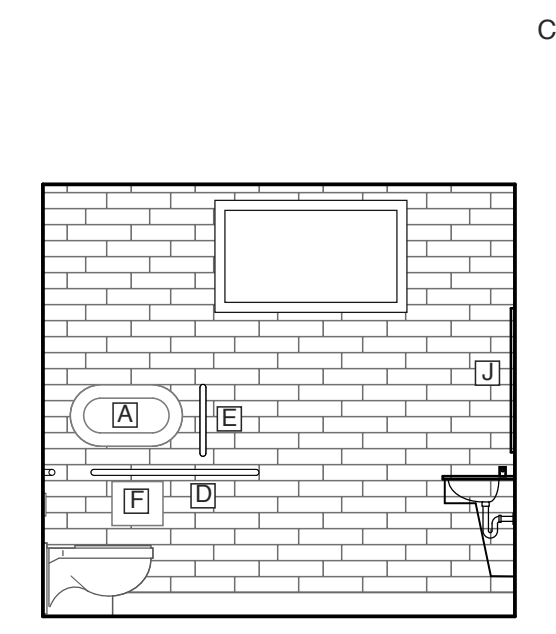
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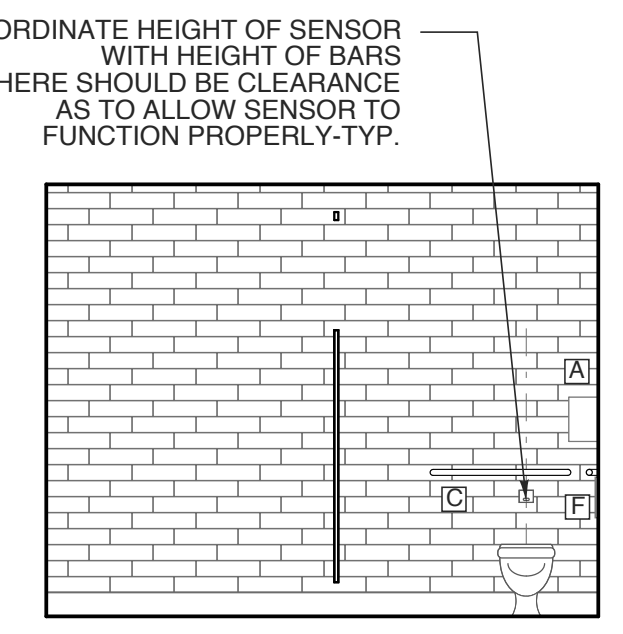
10 ROOM 104 ELEV.
SCALE: 1/4" = 1'-0"

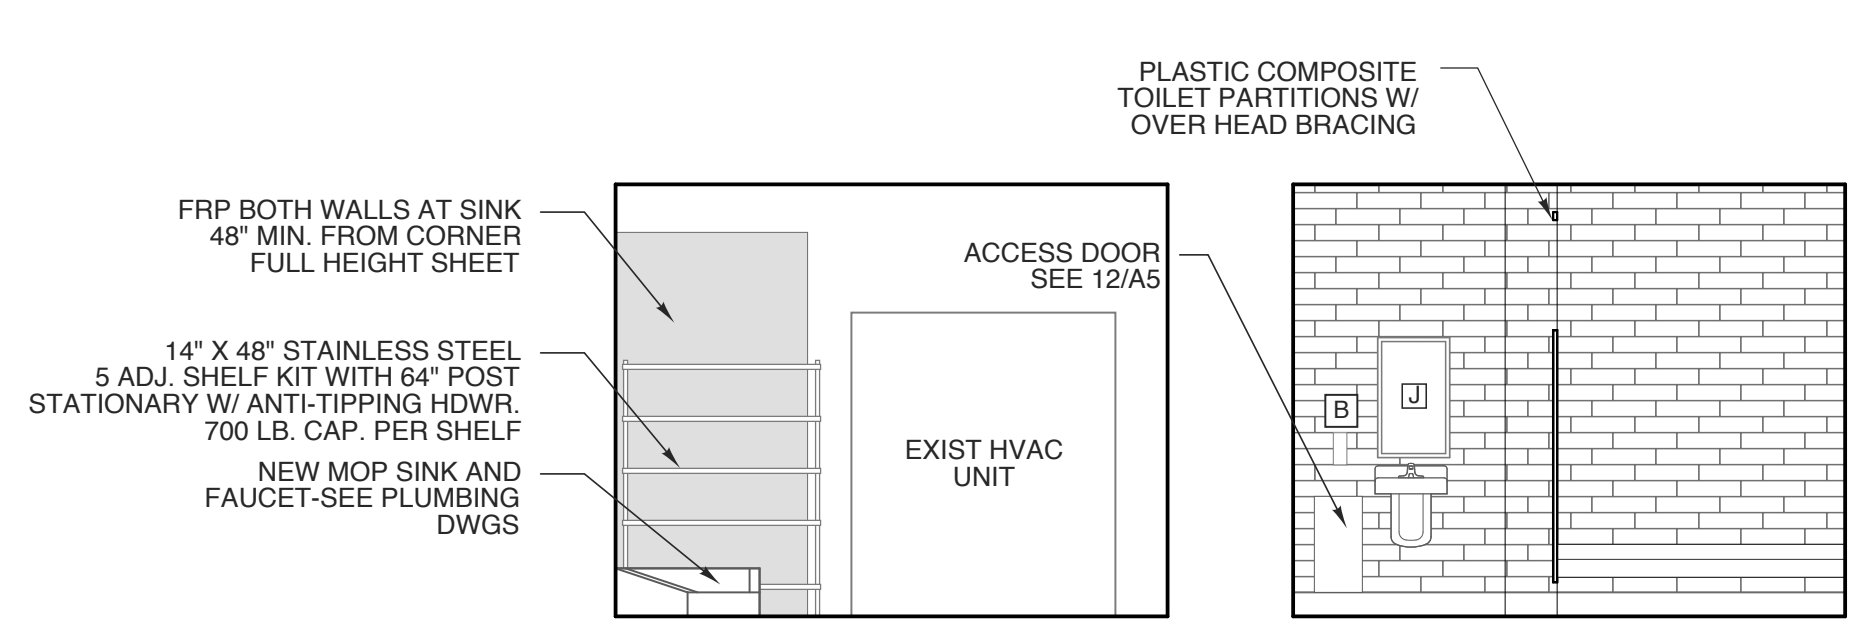


9 ROOM 109 ELEV.
SCALE: 1/4" = 1'-0"

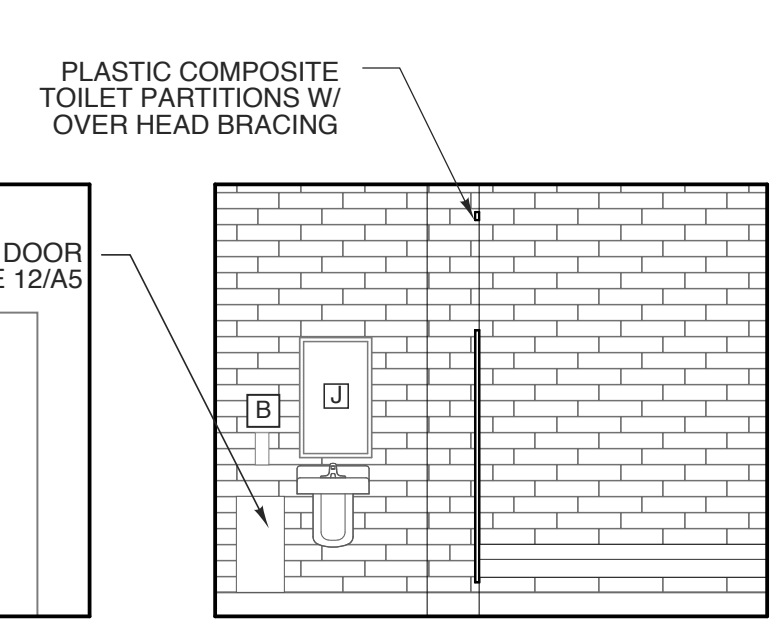


8 ROOM 109 ELEV.
SCALE: 1/4" = 1'-0"




7 ROOM 109 ELEV.
SCALE: 1/4" = 1'-0"

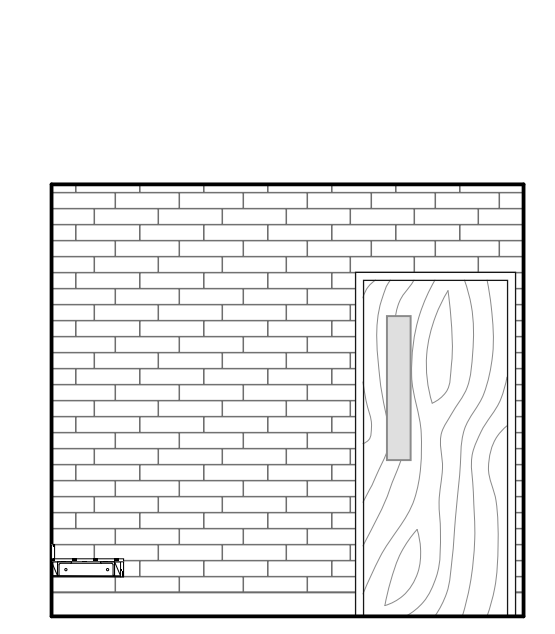


6 ROOM 109 ELEV.
SCALE: 1/4" = 1'-0"

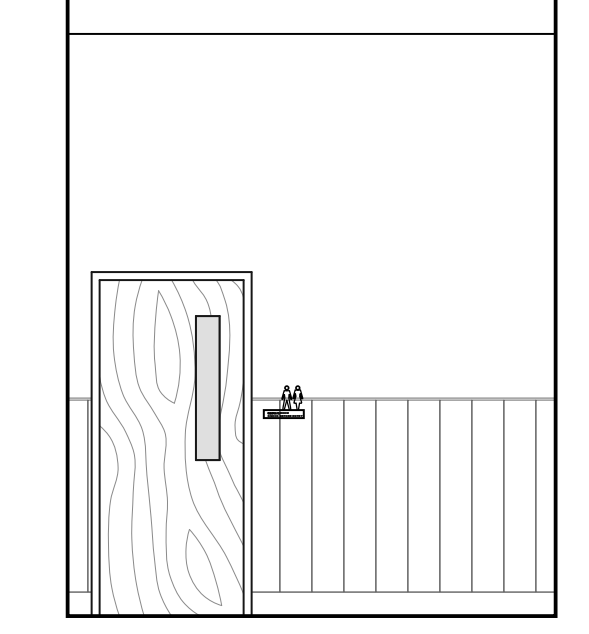

5 ROOM 108 ELEV.
SCALE: 1/4" = 1'-0"

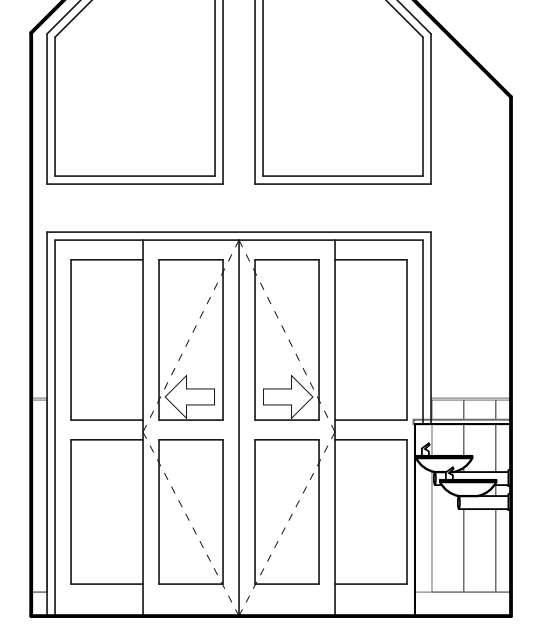

4 ROOM 108 ELEV.
SCALE: 1/4" = 1'-0"

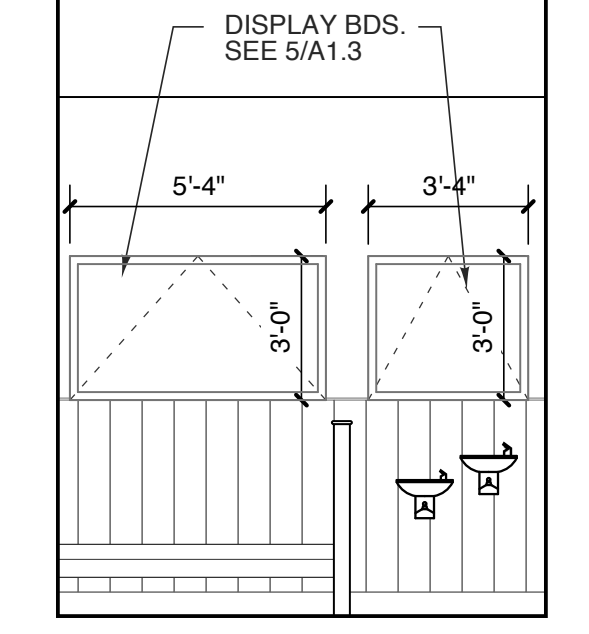

3 ROOM 108 ELEV.
SCALE: 1/4" = 1'-0"

ROOF DRAINAGE LEGEND


- 3" x 4" VERTICAL LEADER
- 5" EAVE GUTTER @ 1:16 SLOPE

NOTE: EXIST GUTTERS NOT SHOWN FOR CLARITY EXIST. GUTTER & DS TO REMAIN EXCEPT AS NOTED


ROOF DRAINAGE CALCULATIONS
PER 2012 NC PLUMBING CODE

TABLE 1106.2 (2) RECTANGULAR VERTICAL LEADERS
3X4 @ 4"/HR 3,300 SF MAX AREA


TABLE 1106.6 SIZE OF SEMI-CIRCULAR ROOF GUTTERS
5" DIA. @4"/HR 625 SF MAX AREA @ 1/16: 12 (1/2%) SLOPE

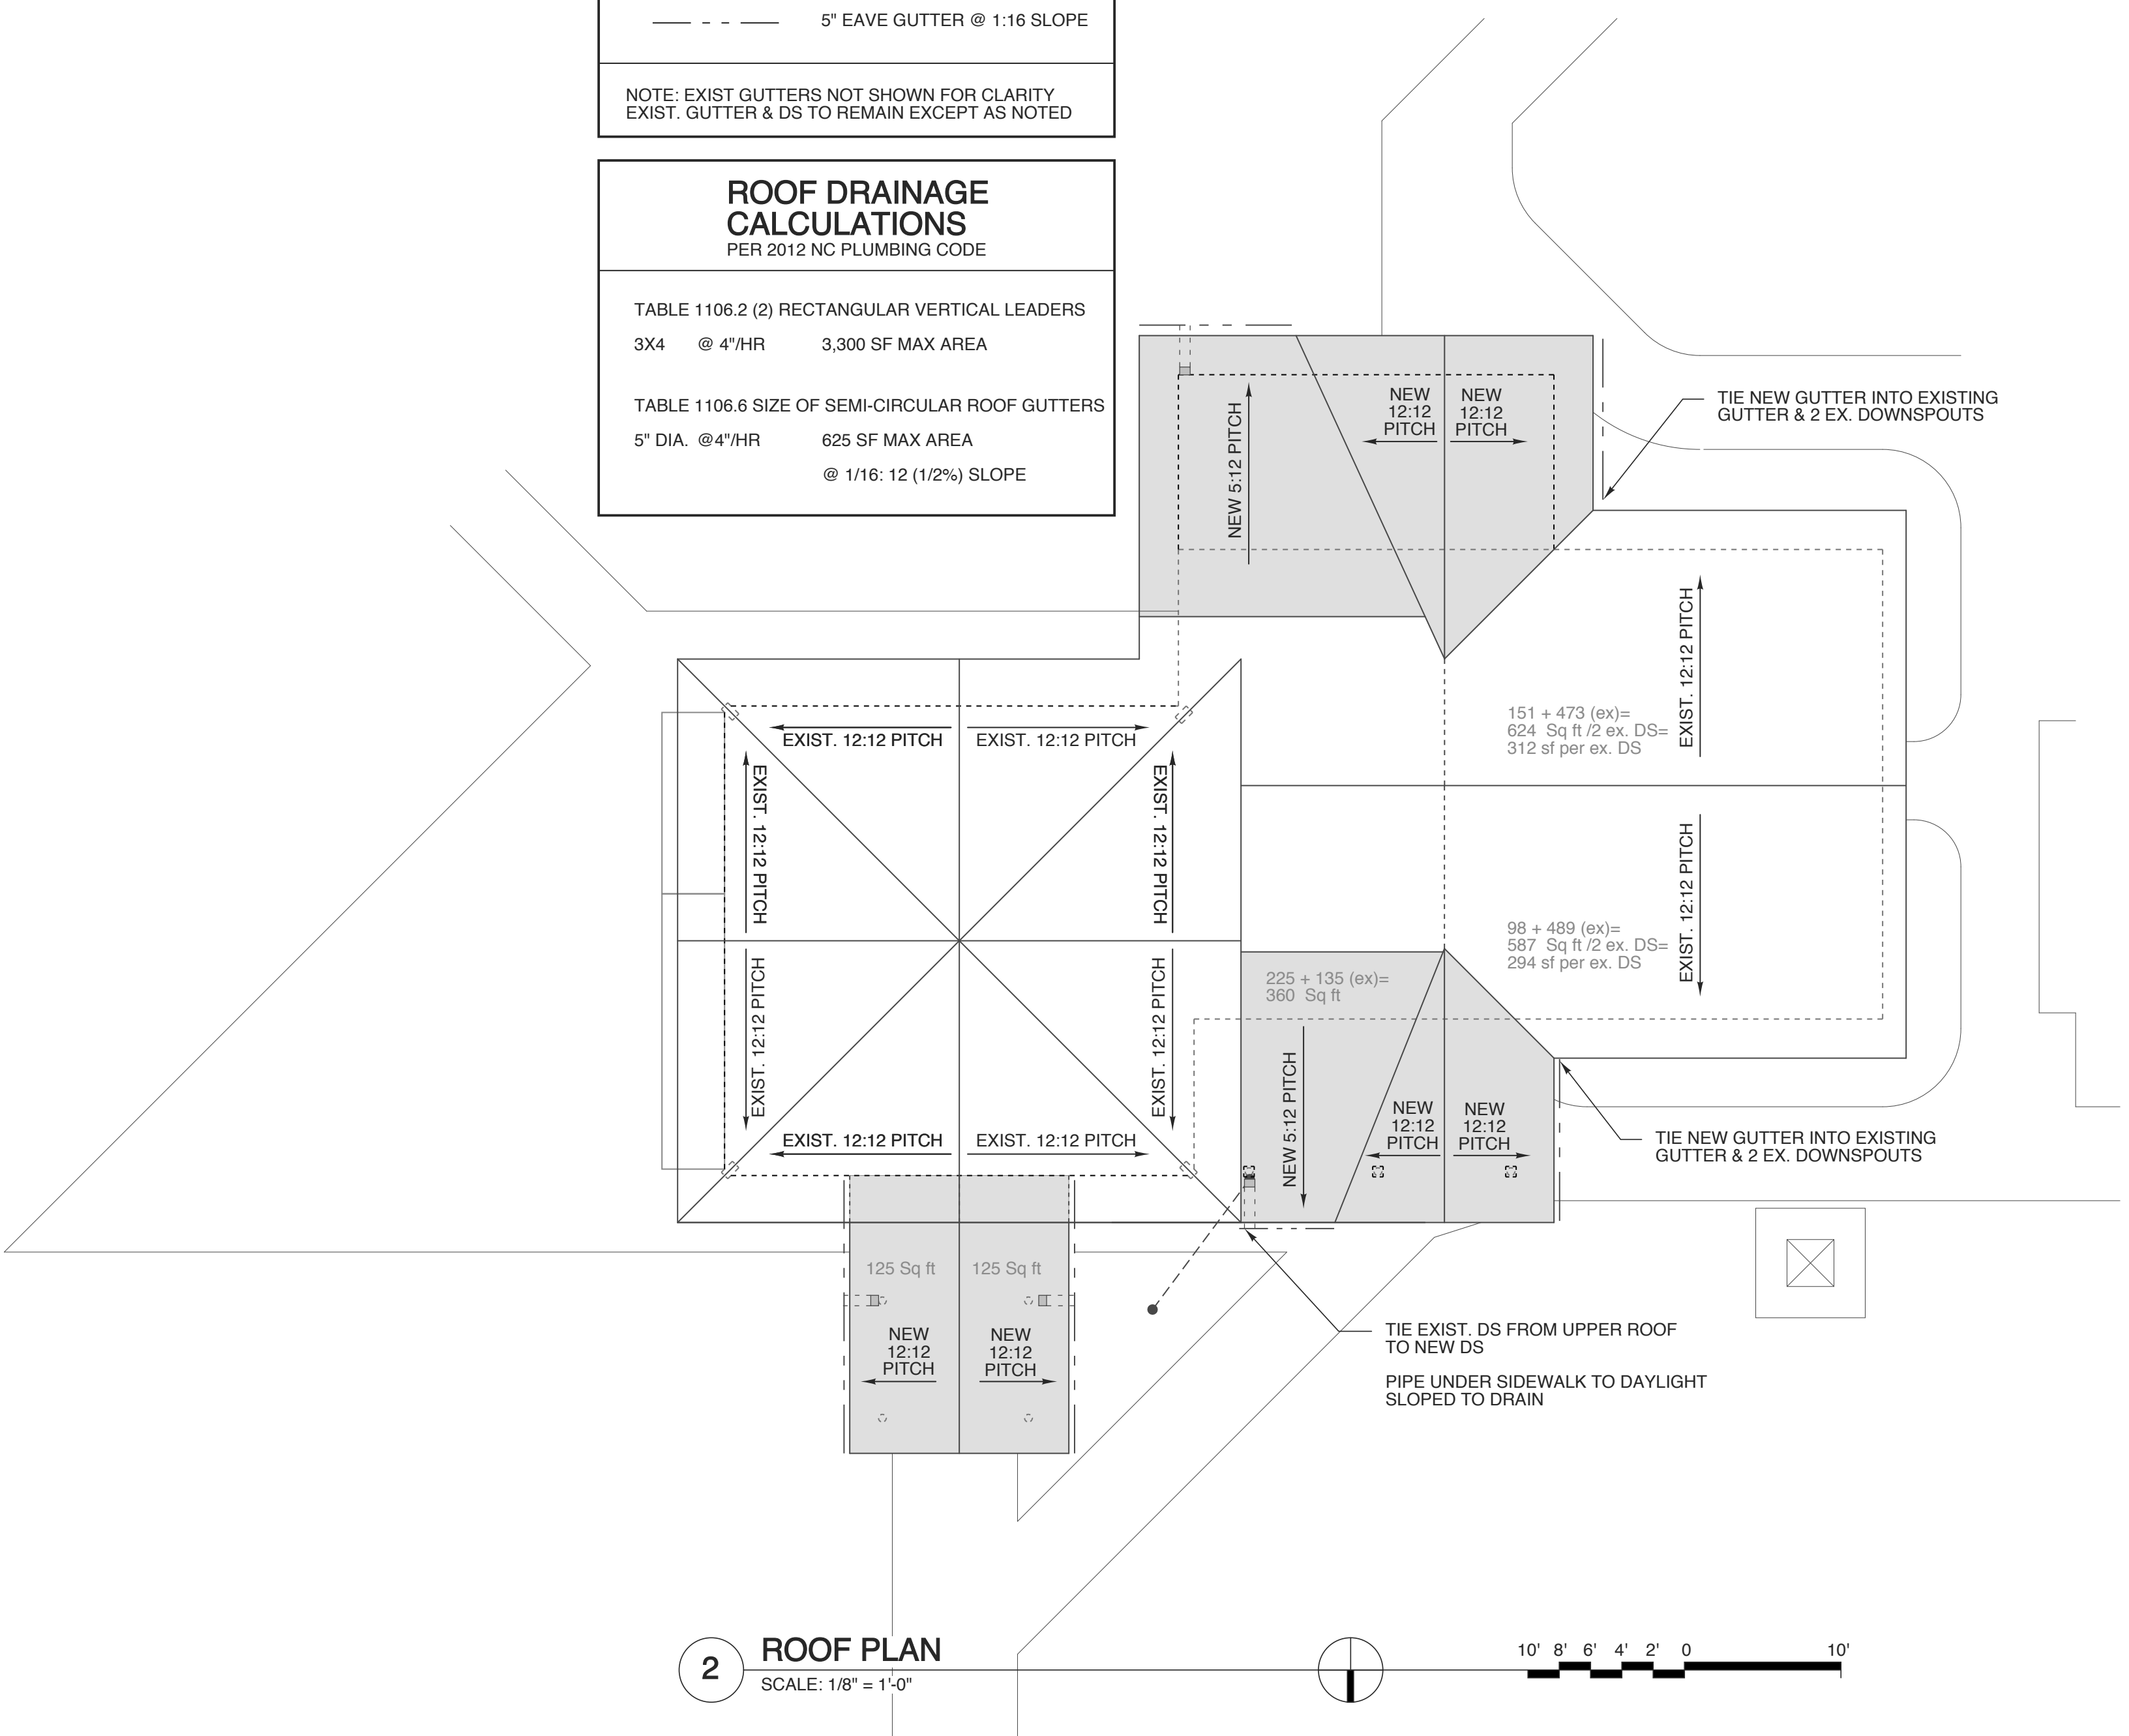


2 ROOF PLAN
SCALE: 1/8" = 1'-0"

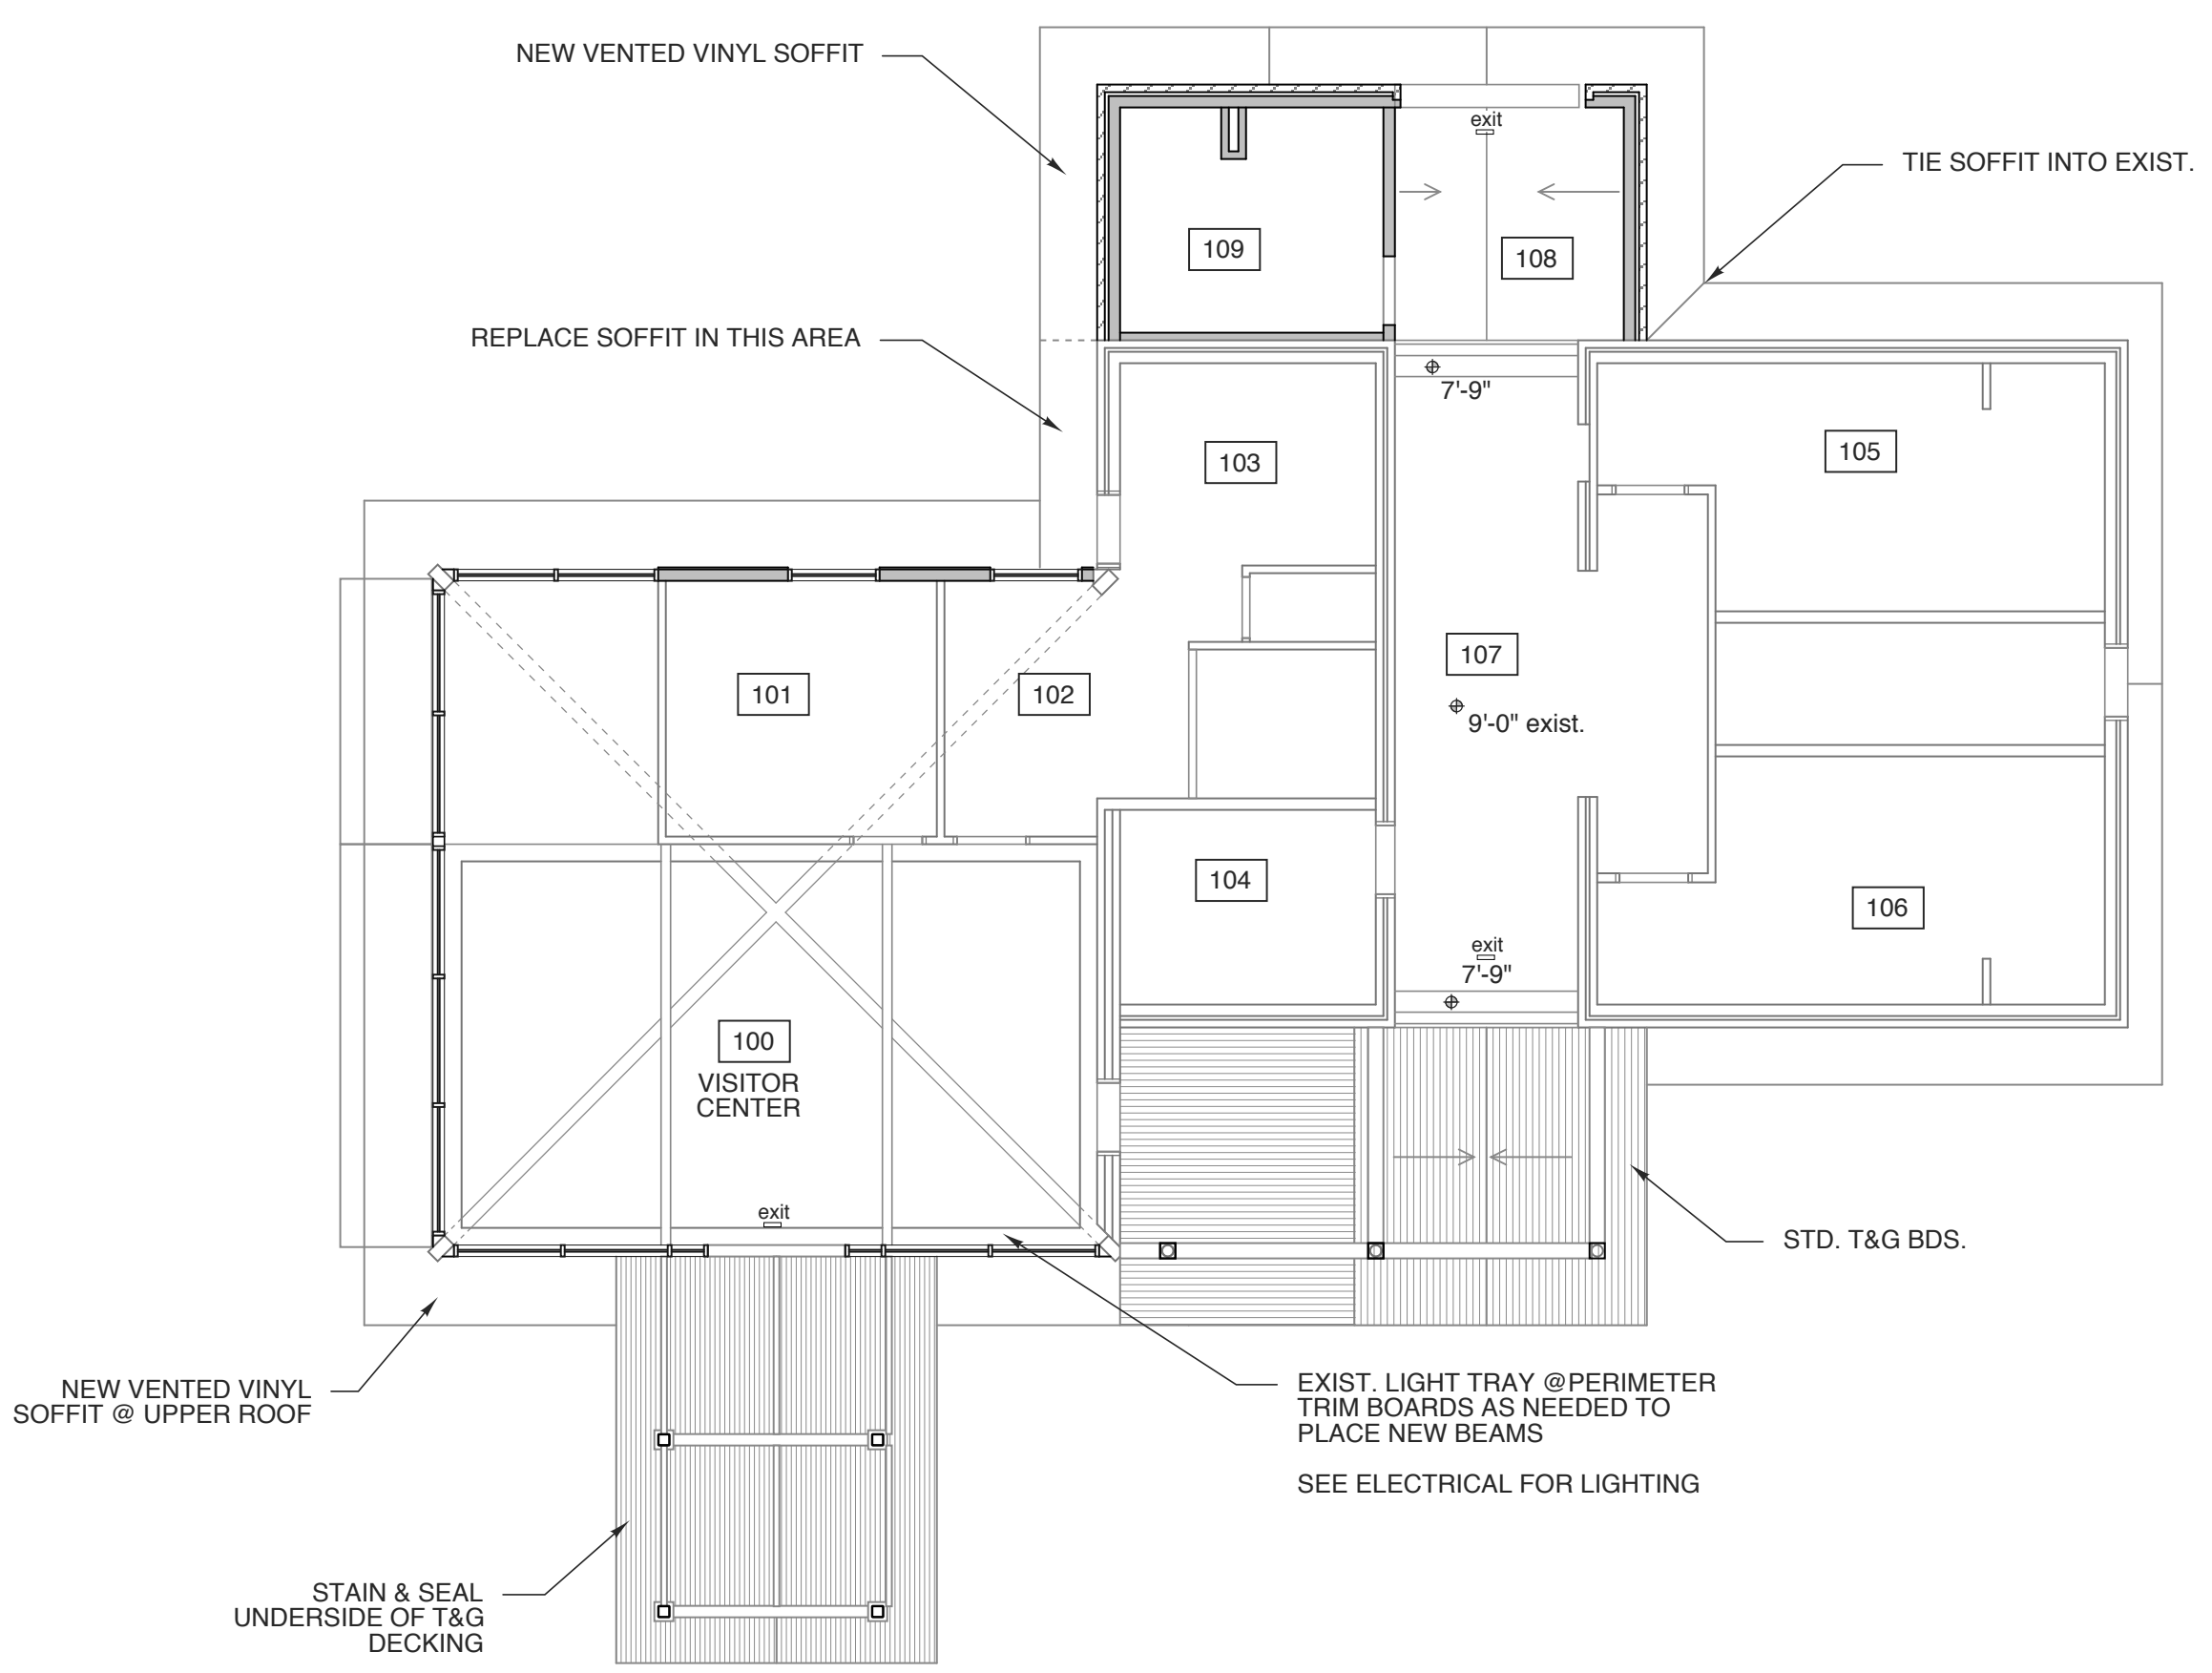

1 RCP
SCALE: 1/8" = 1'-0"

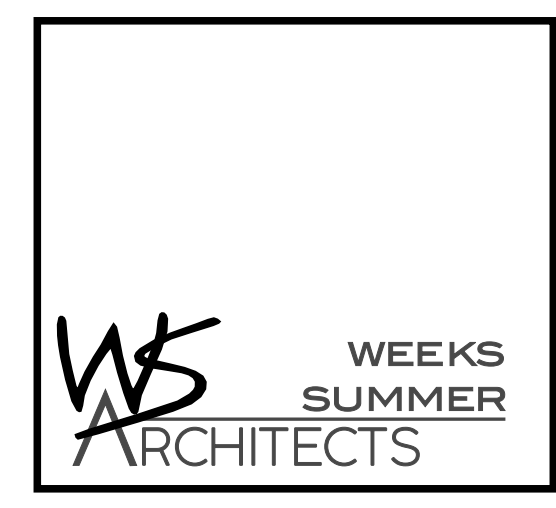

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PROJECT TITLE
BRUNSWICK CTY VISTOR'S CENTER
394 WHITEVILLE ROAD NW
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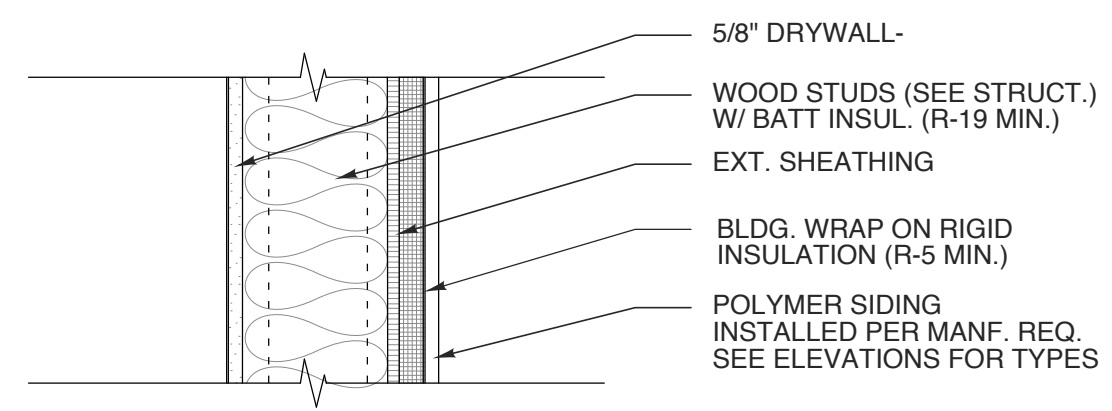
PROJECT NO.
2104a
DRAWING TITLE
RCP & ROOF PLAN

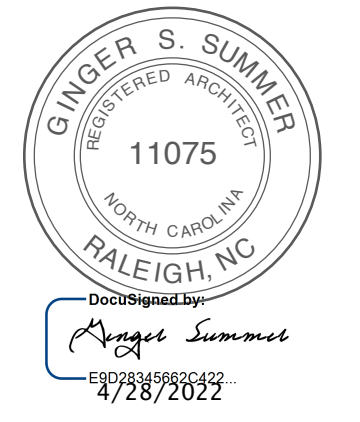SHEET 6 OF 12


A1.4

PLOT DATE 4/28/22
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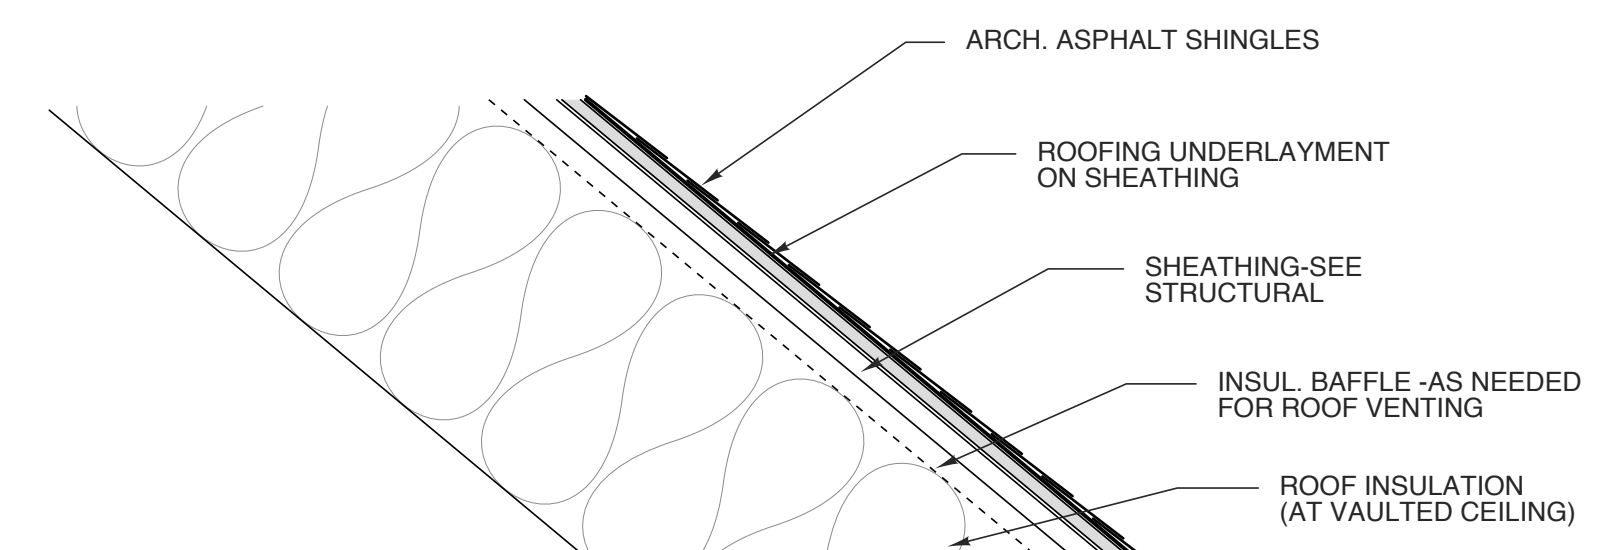
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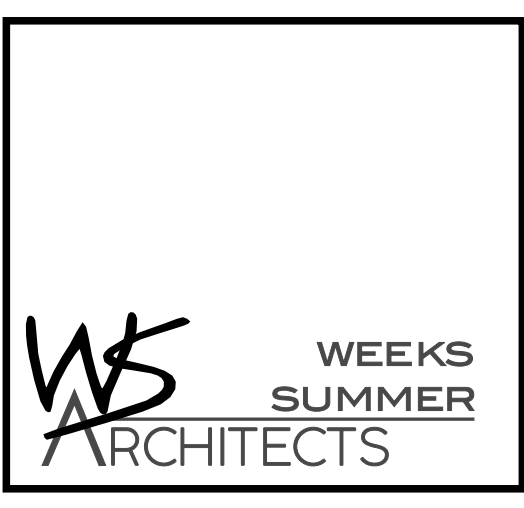
7 TYPICAL SIDING WALL
SCALE: 1 1/2" = 1'-0"




6 TYPICAL BRICK VENEER WALL
SCALE: 1 1/2" = 1'-0"

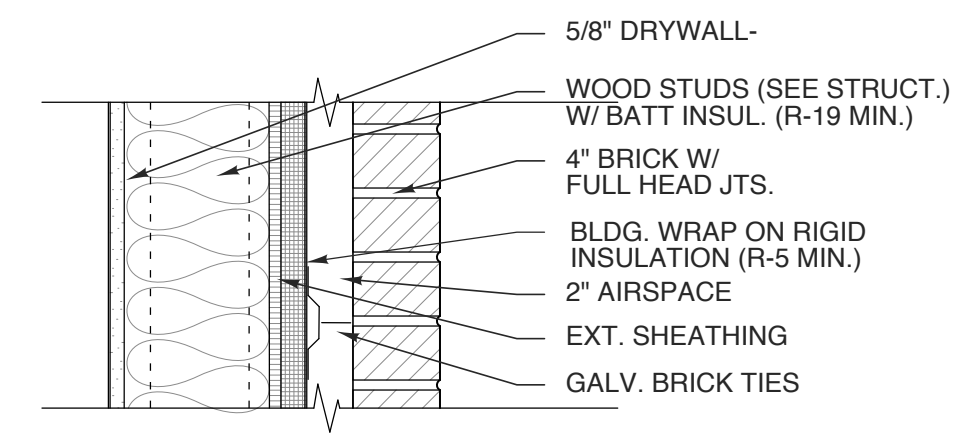


5 TYPICAL SHINGLE ROOF
SCALE: 1 1/2" = 1'-0"



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4 ELEVATION
SCALE: 1/8" = 1'-0"

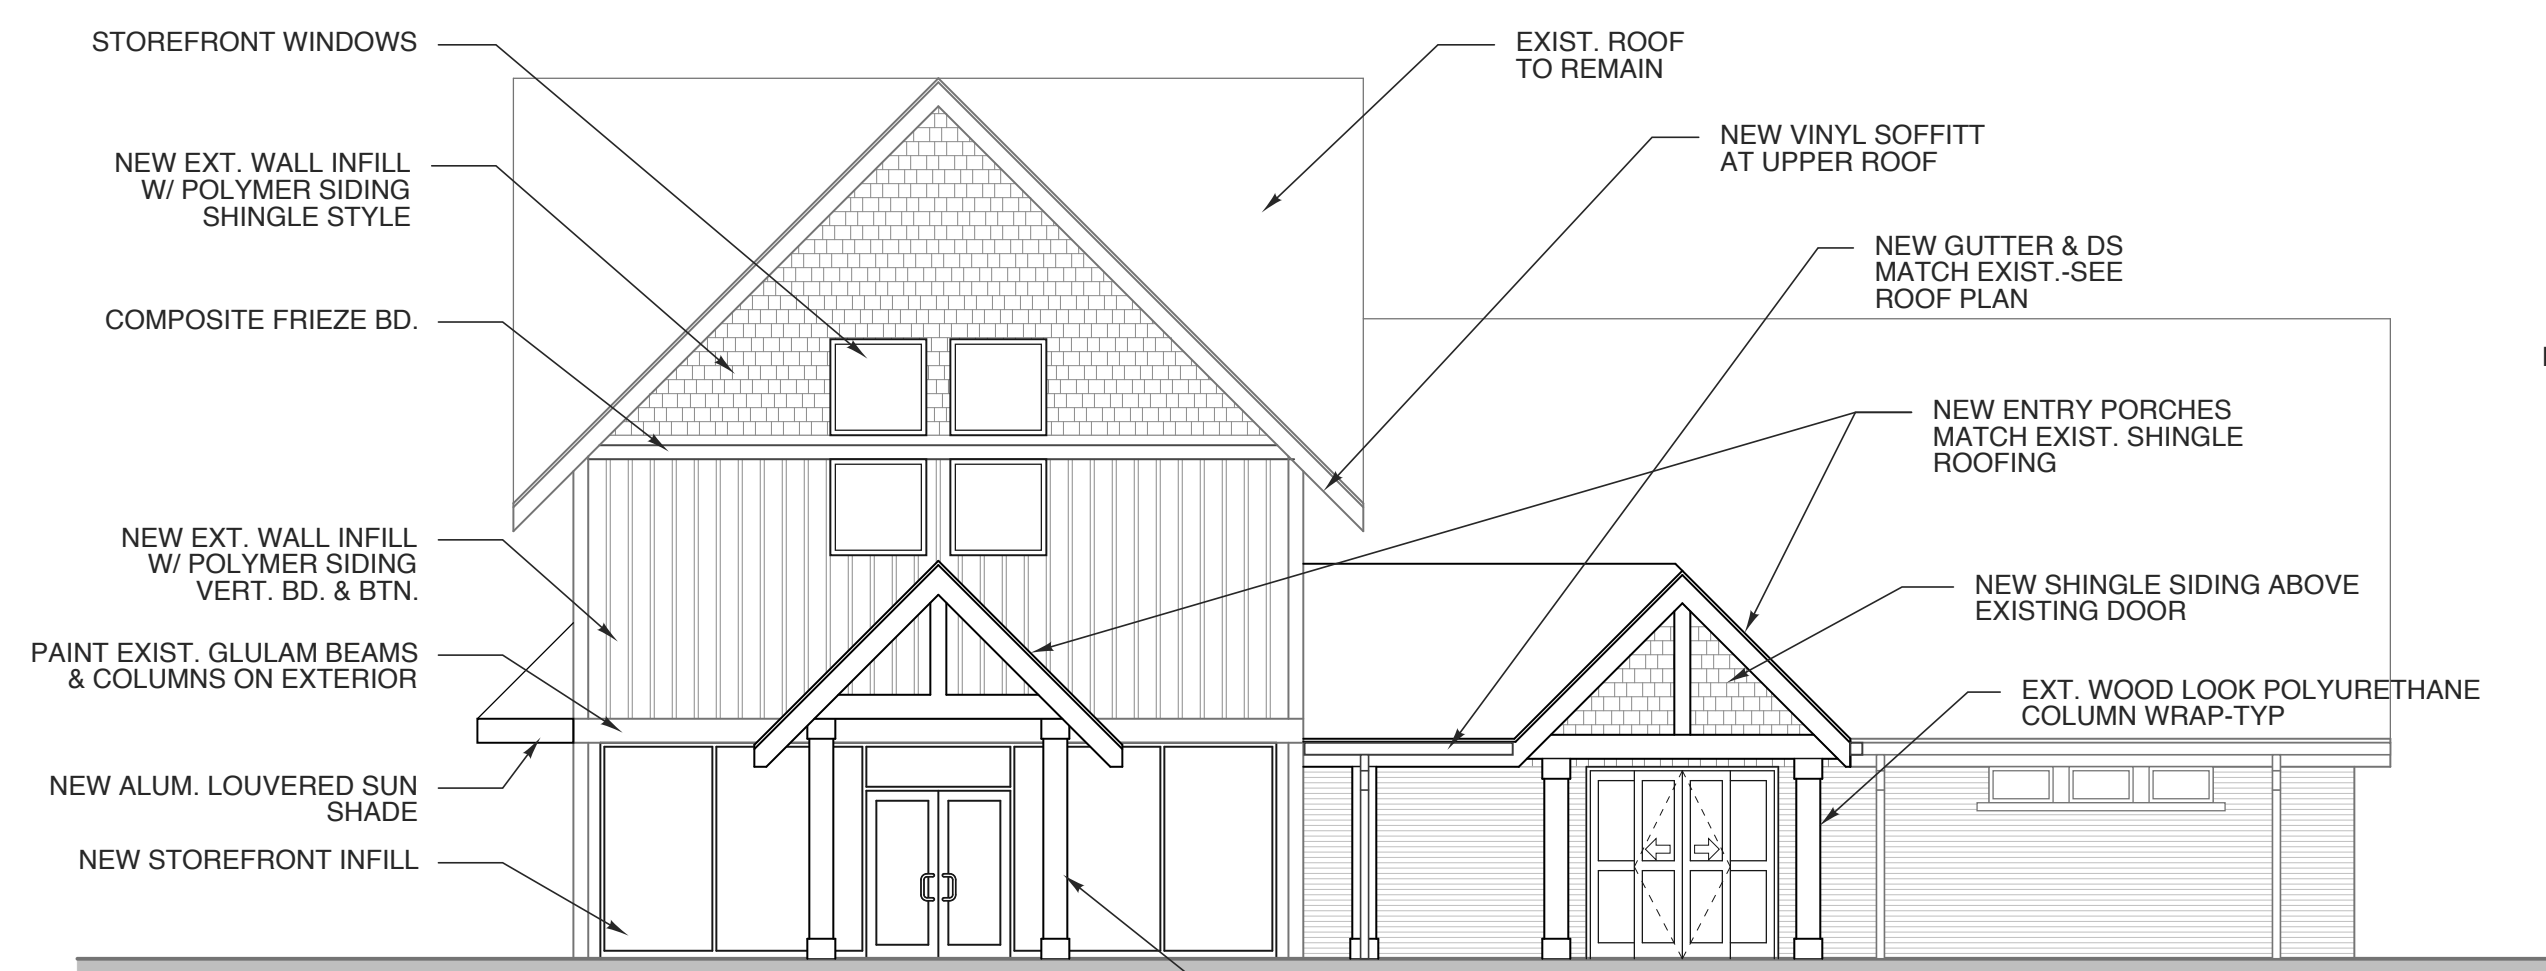

3 ELEVATION
SCALE: 1/8" = 1'-0"

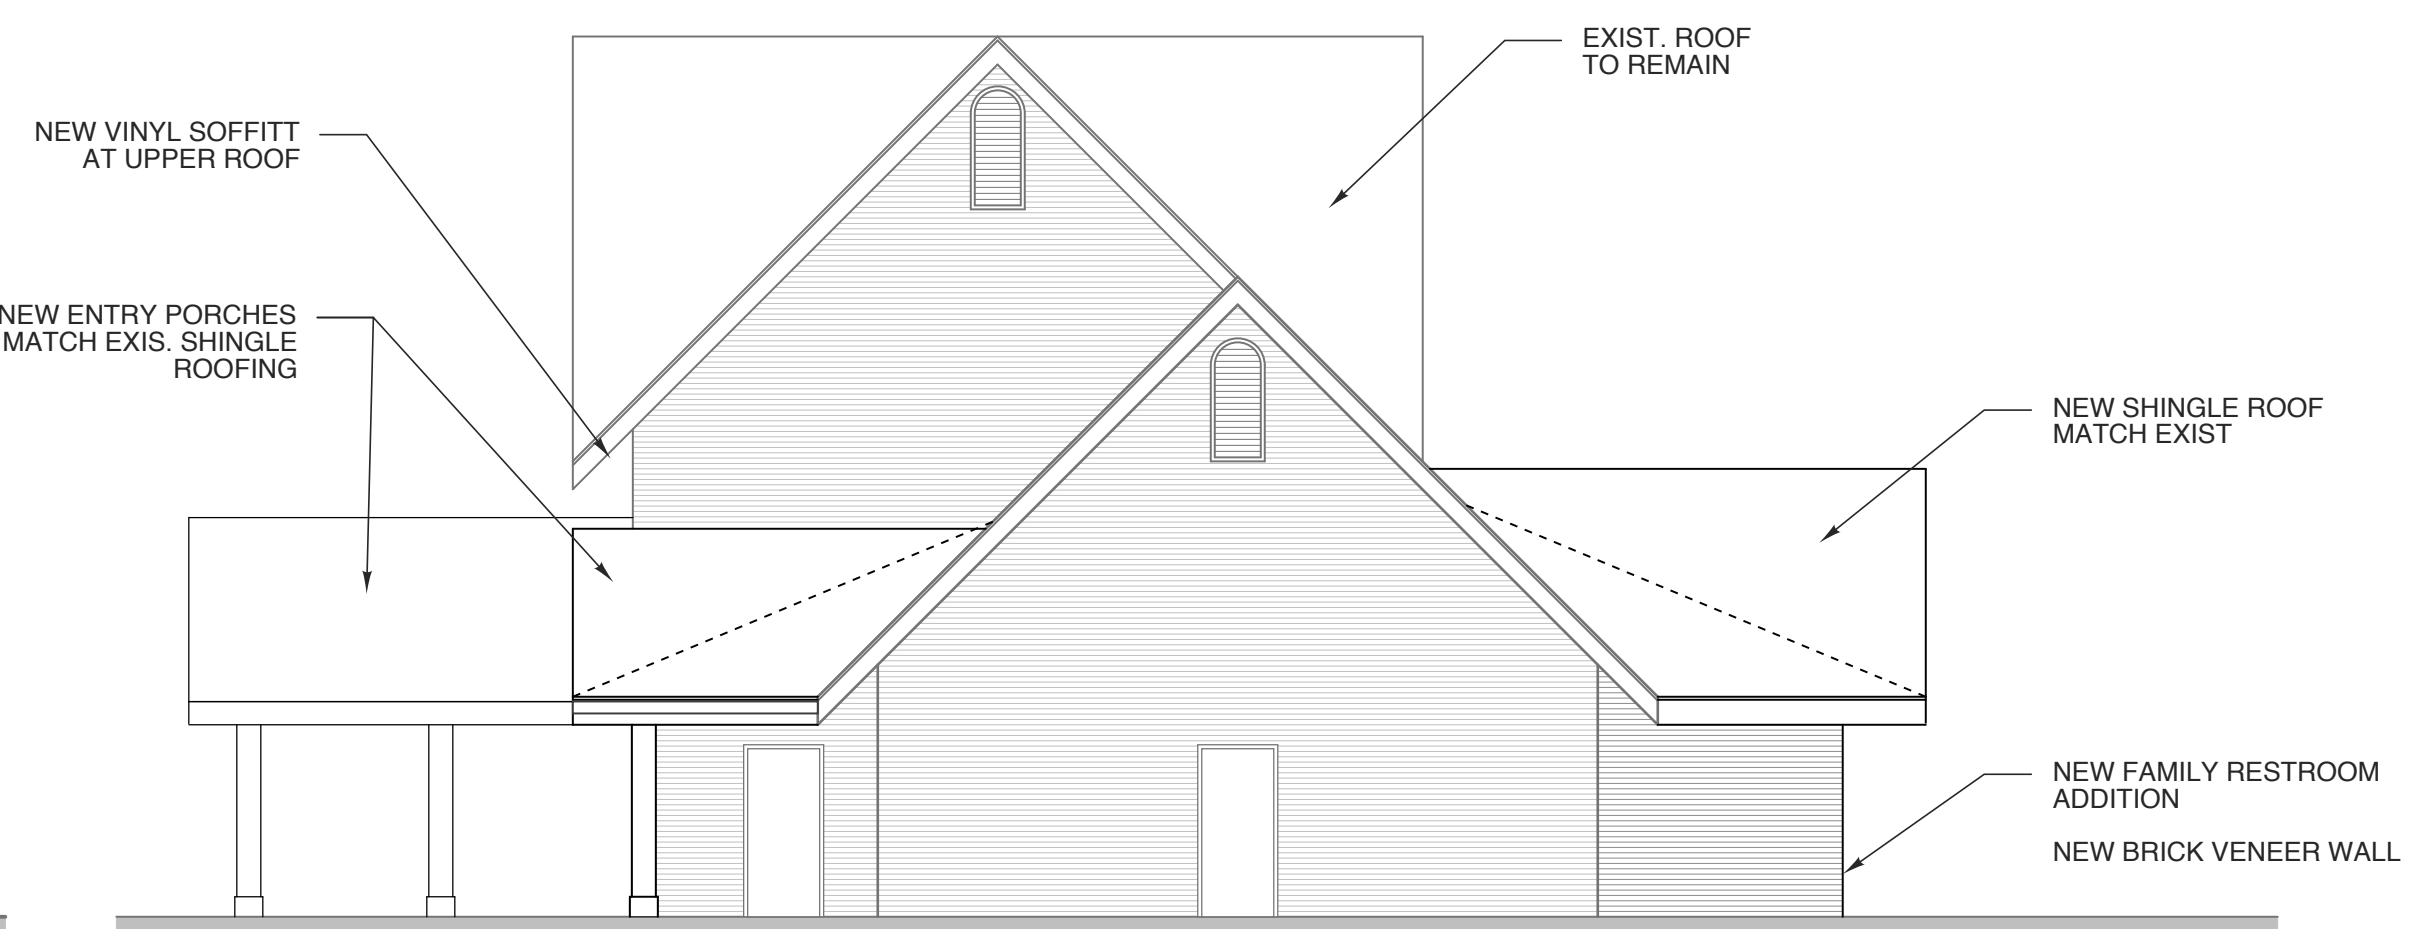

2 ELEVATION
SCALE: 1/8" = 1'-0"



1 ELEVATION
SCALE: 1/8" = 1'-0"

BID SET 4.28.22
WBS: 15RE.13.3
SCO ID# 21-24079-01A

PROJECT TITLE
BRUNSWICK CTY VISTOR'S CENTER
384 WHITEVILLE ROAD NW
SHALLOTE, NORTH CAROLINA


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2104a
DRAWING TITLE
ELEVATIONS

SHEET 7 OF 12



A2

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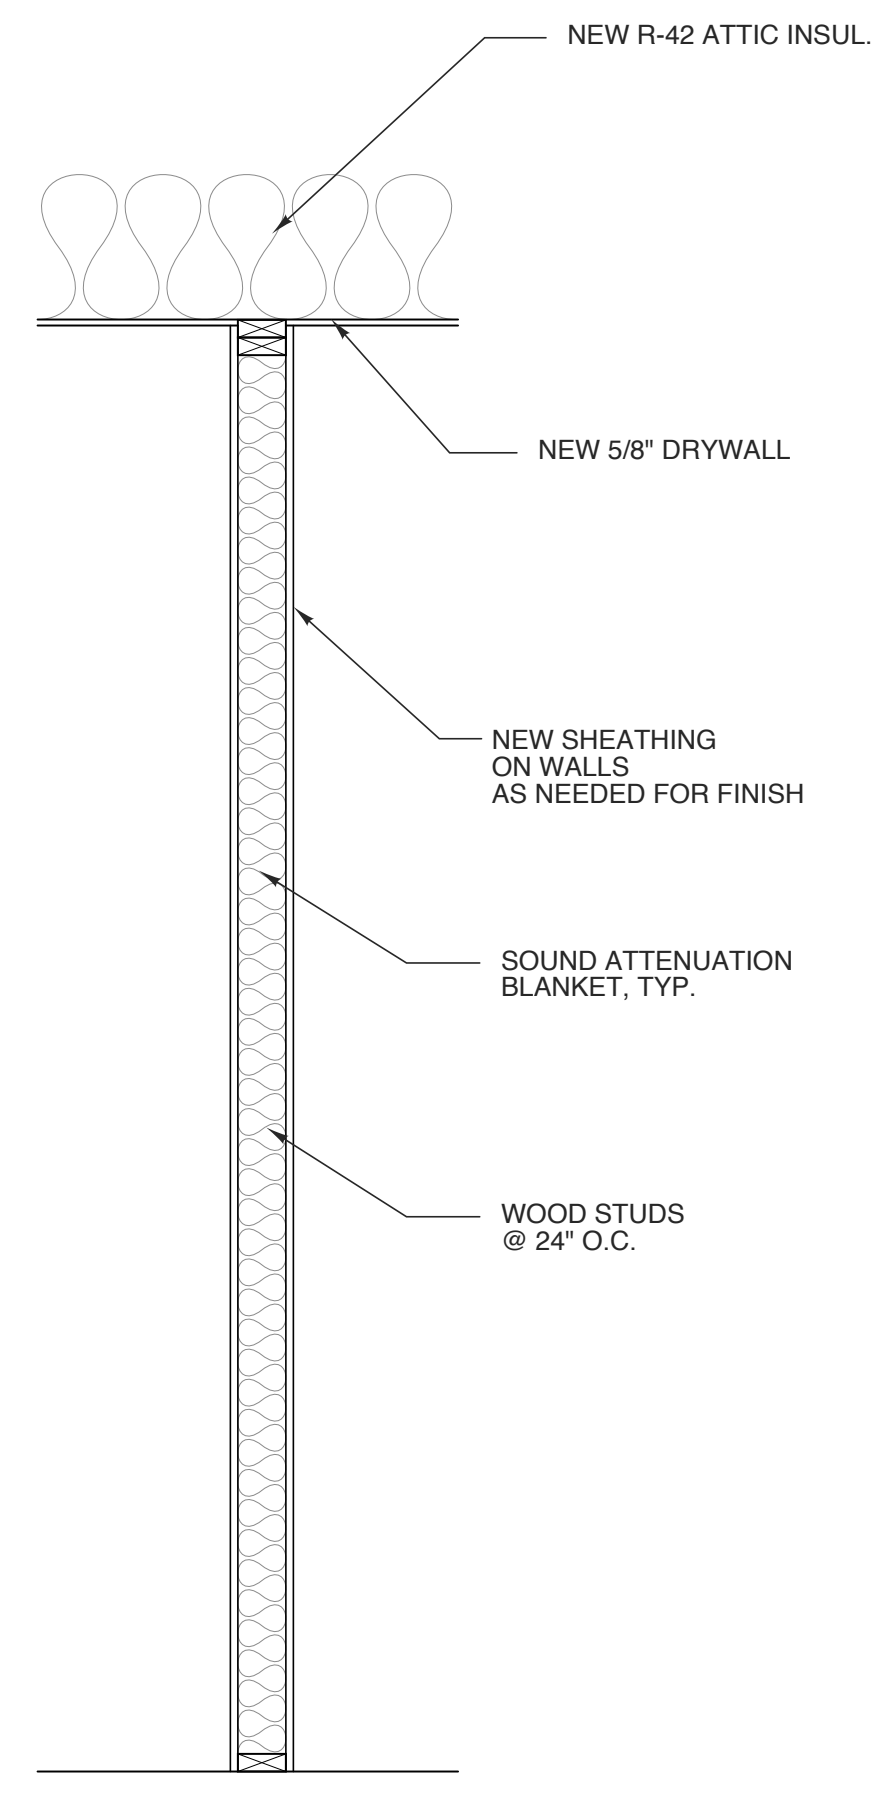


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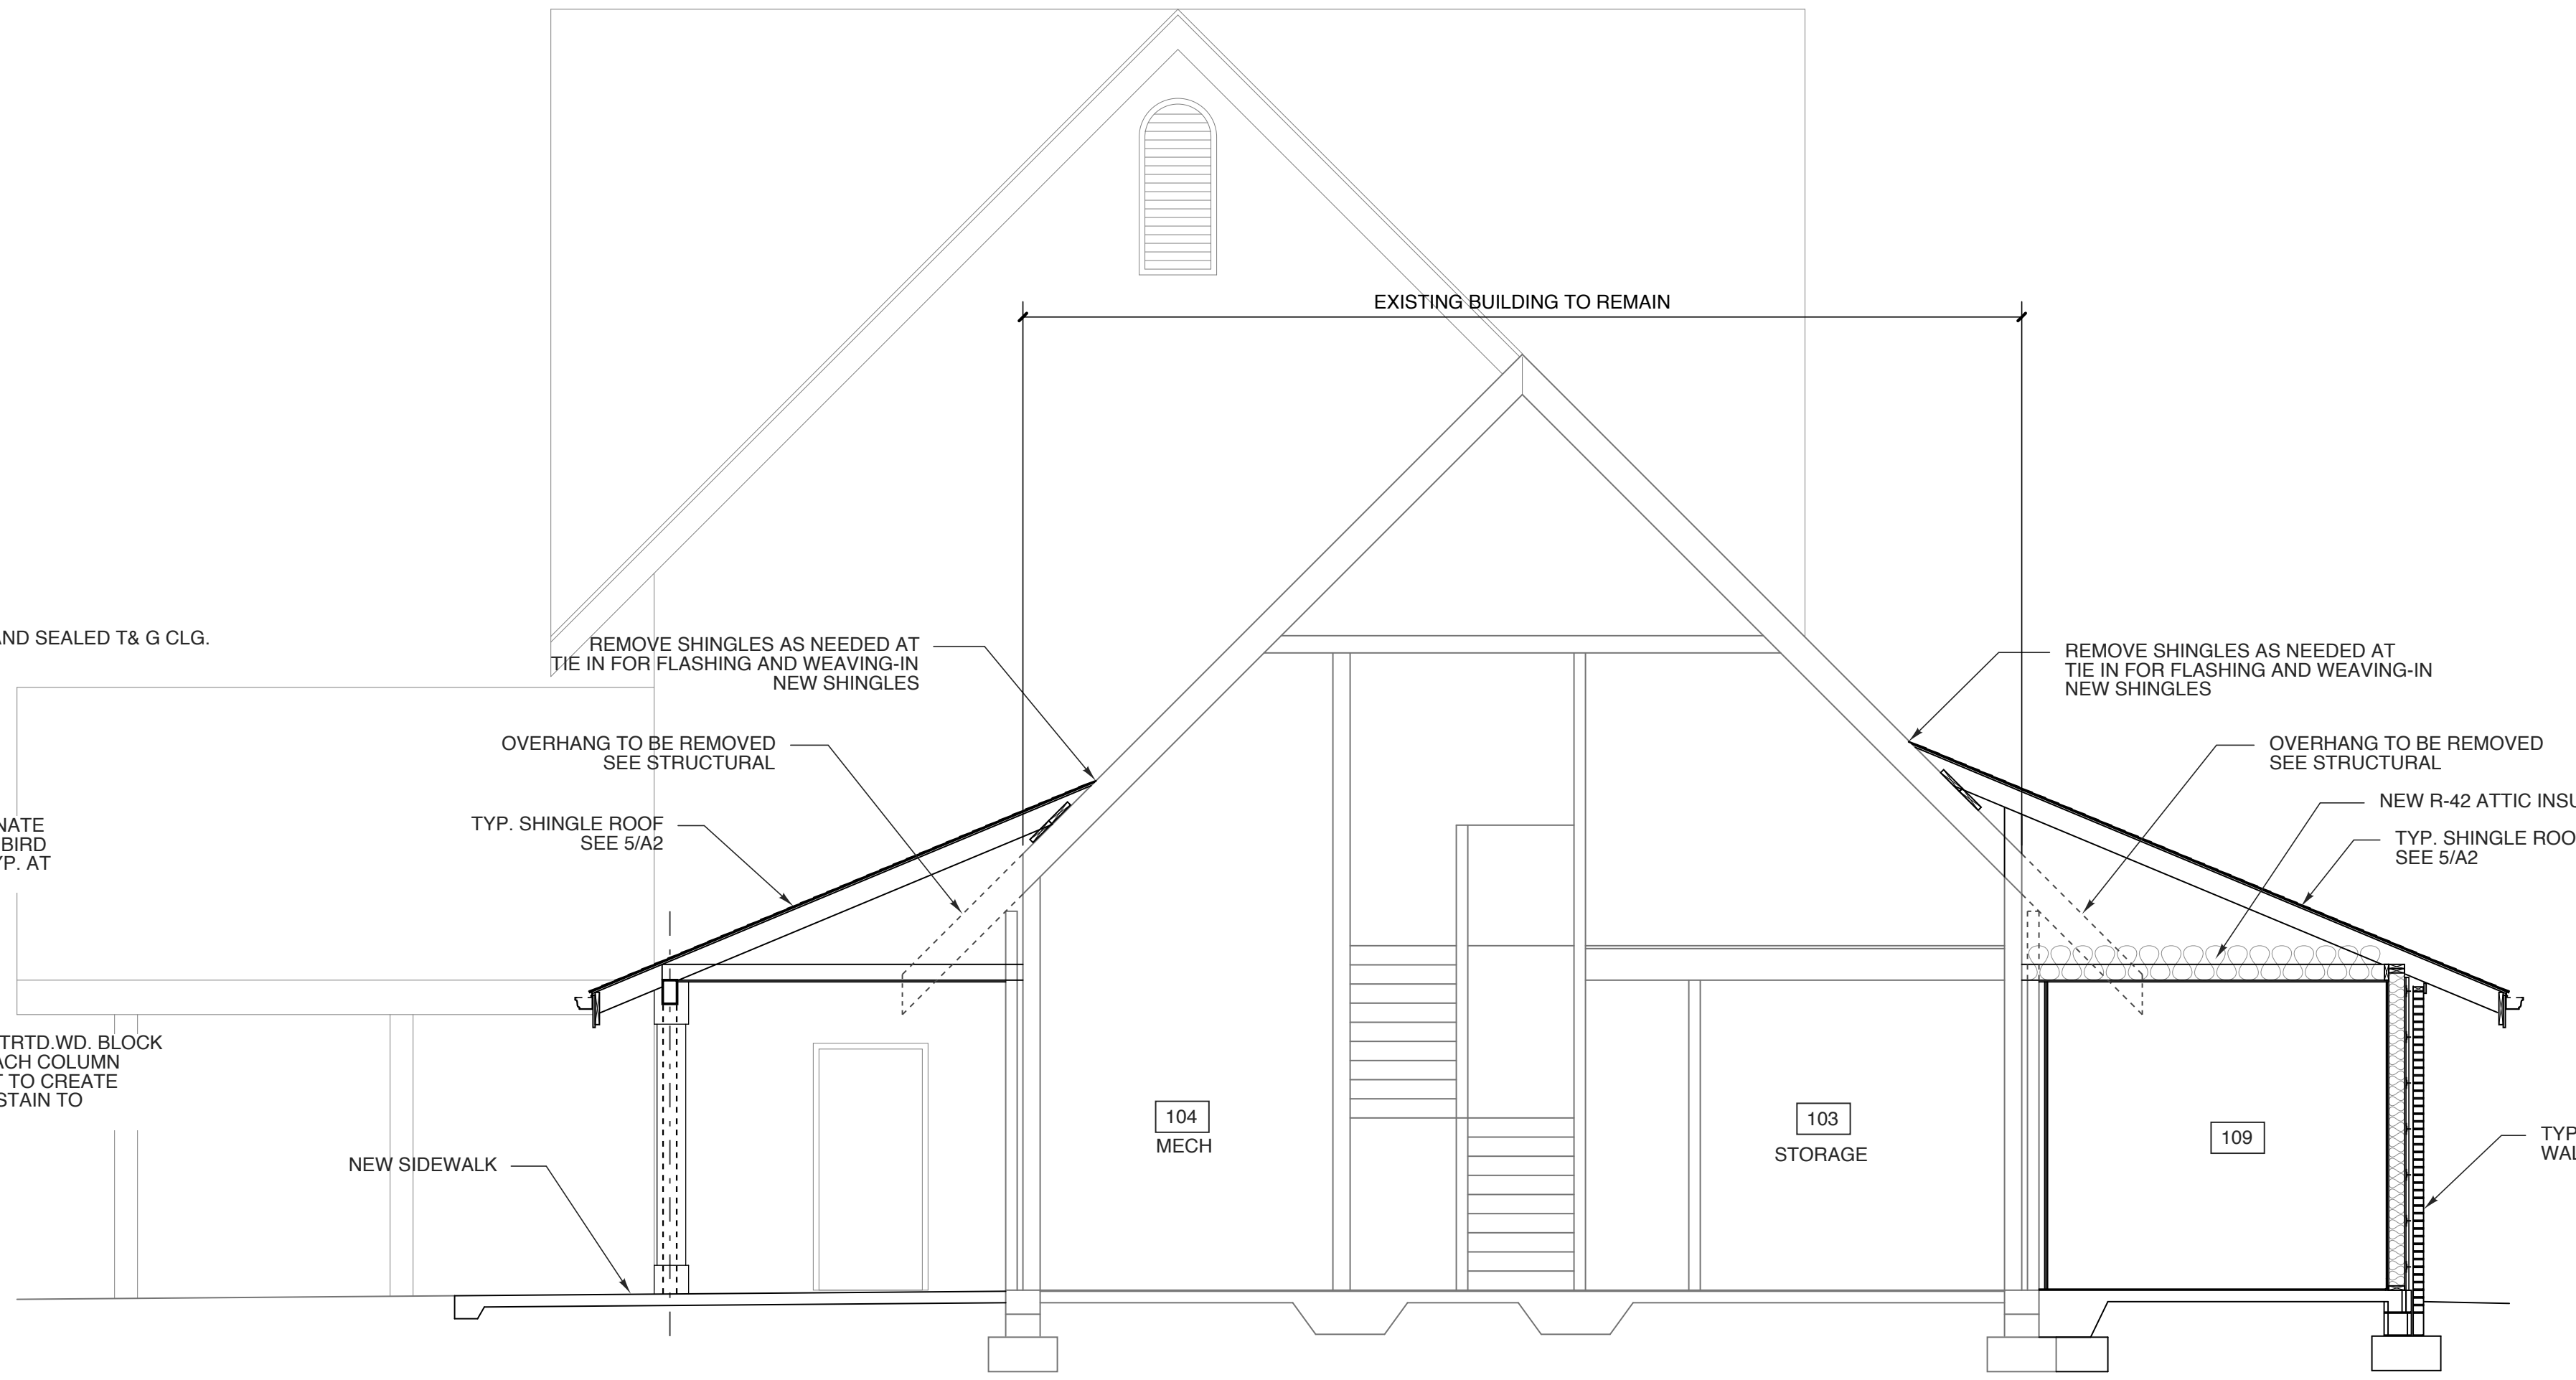


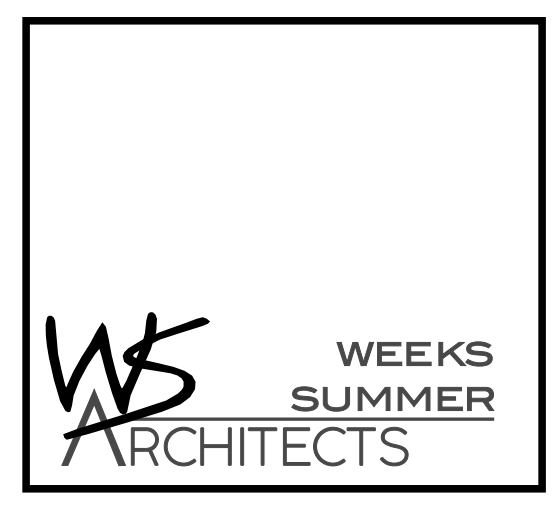4 SECT. @ ENTRY TO VISITOR CTR.
SCALE: 1/4" = 1'-0"


NOTES
FOR FOUNDATION AND FRAMING
INFORMATION-SEE STRUCTURAL
FOR FINISH INFORMATION SEE
FINISH SCHEDULE

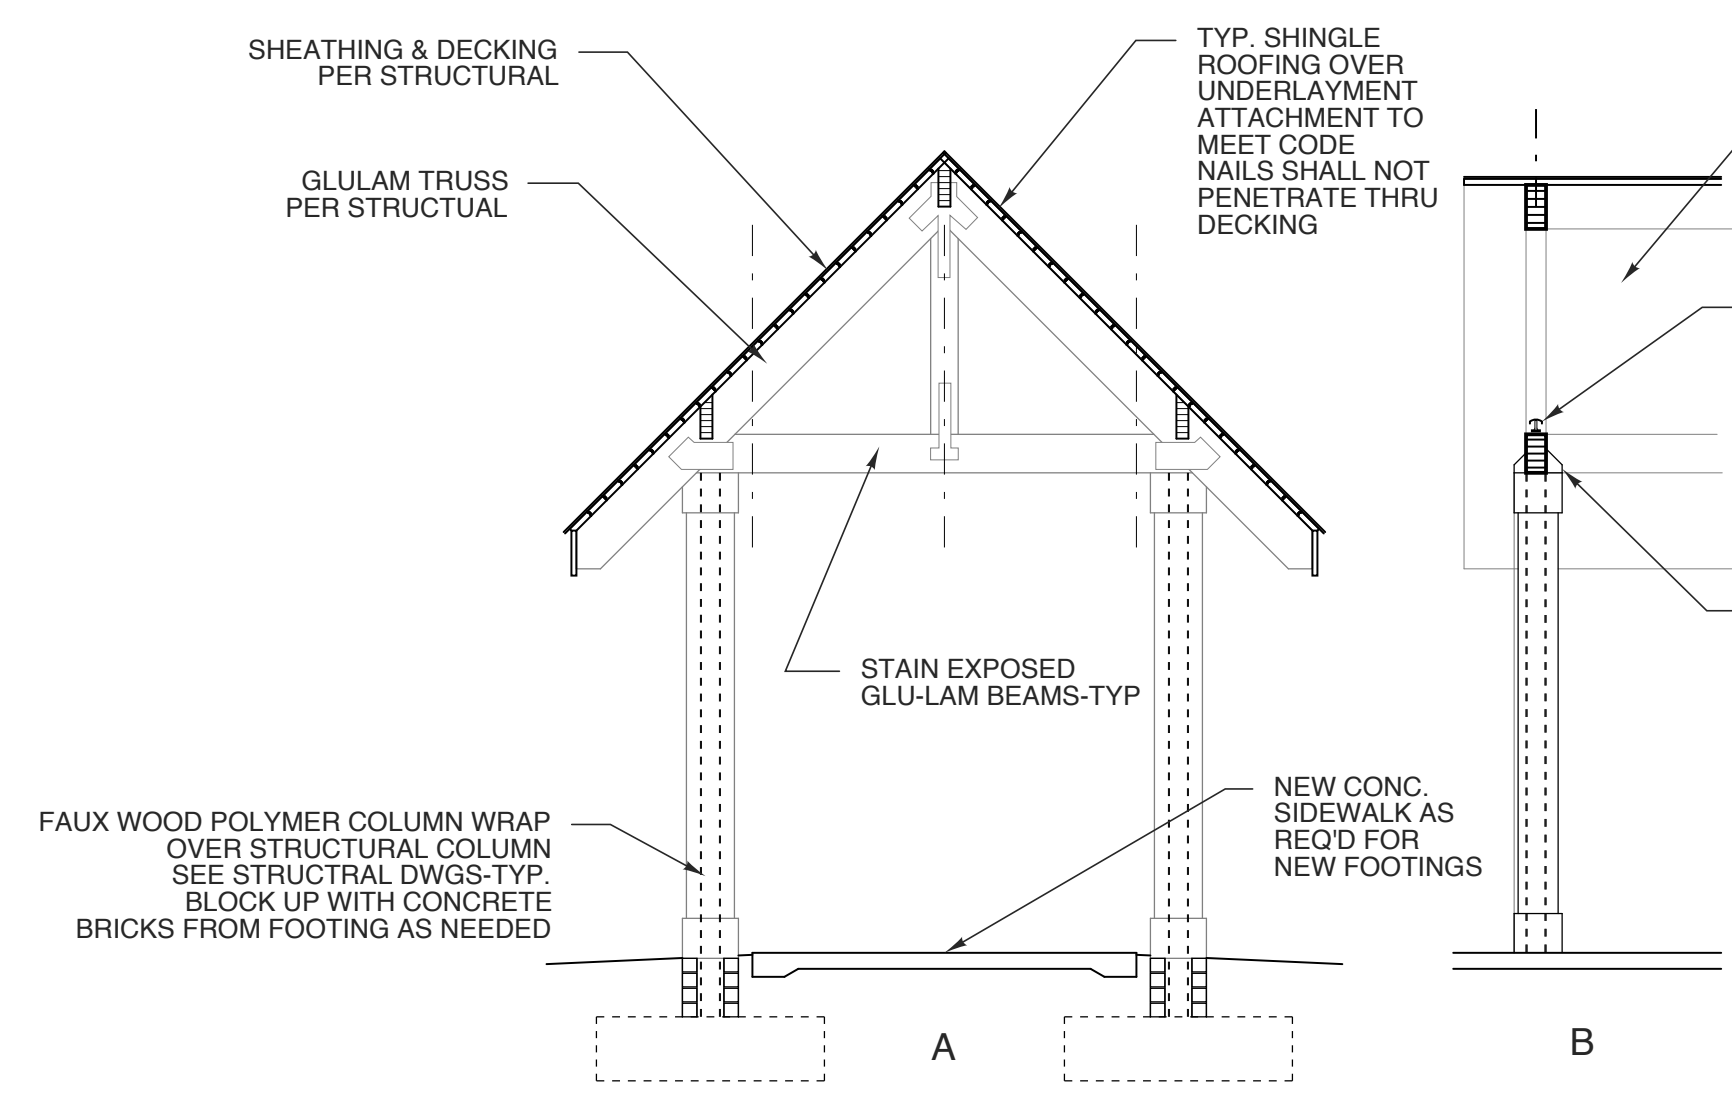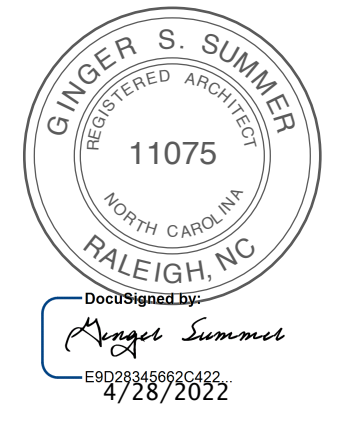

3 TYP. INT. WALL SECT.
SCALE: 3/4" = 1'-0"



2 SECTION THRU FAMILY RESTROOM
SCALE: 1/4" = 1'-0"

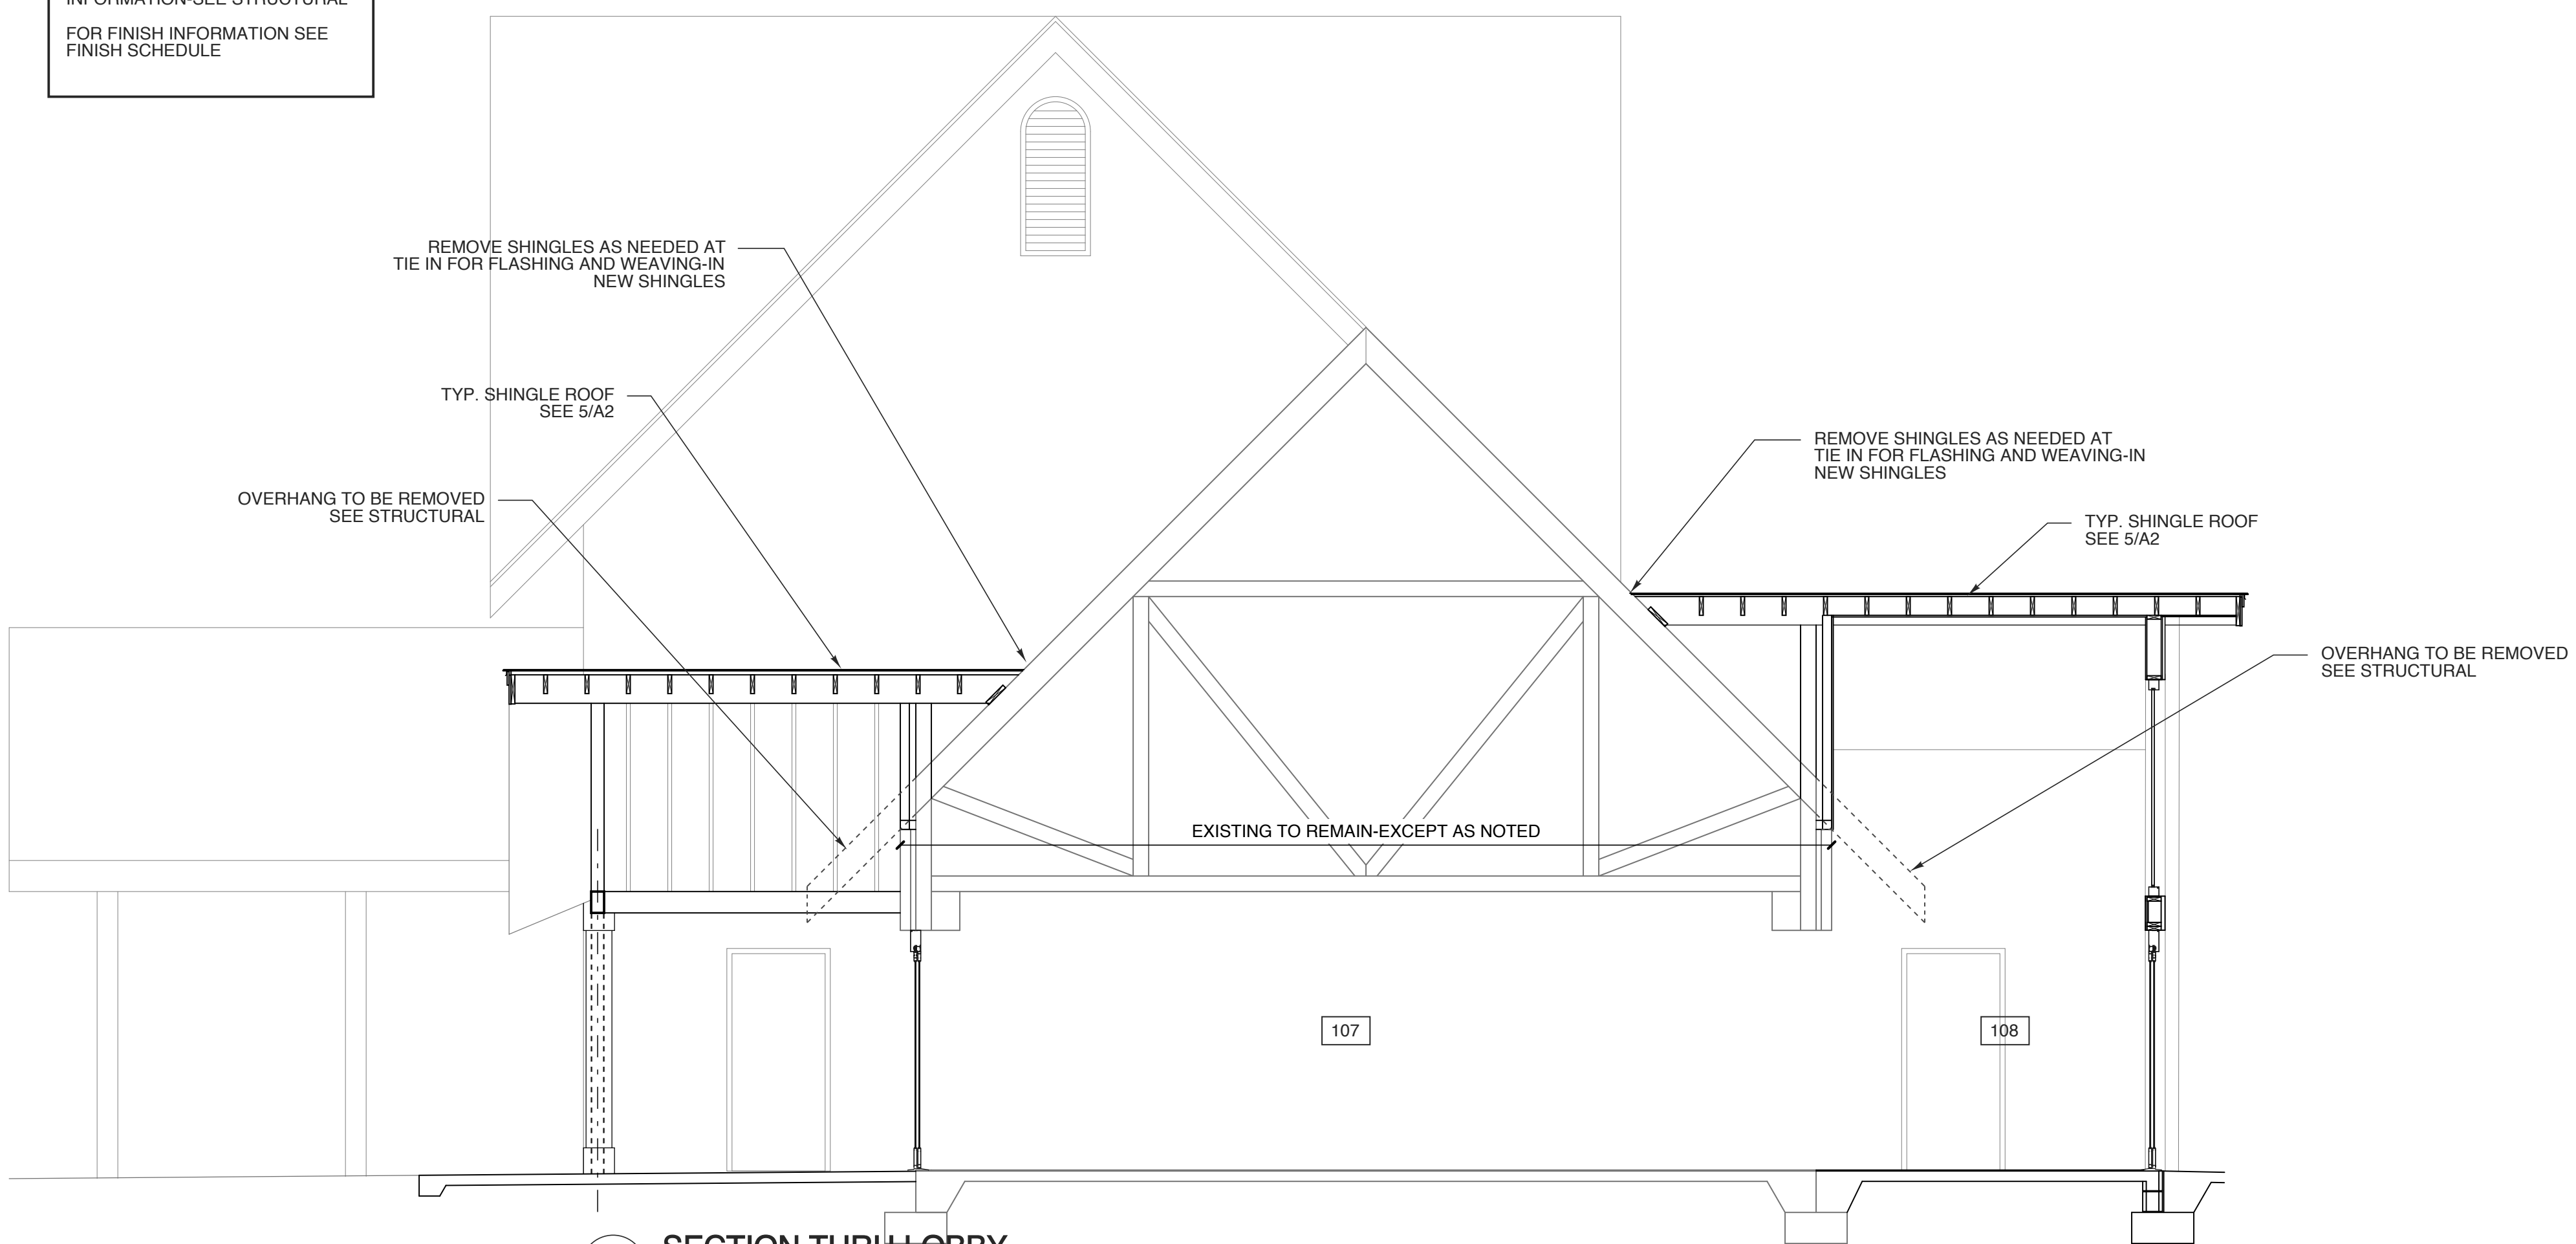

1 SECTION THRU LOBBY
SCALE: 1/4" = 1'-0"

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SCO ID# 21-24079-01A

PROJECT TITLE
**BRUNSWICK CTY
VISTOR'S CENTER**
394 WHITEVILLE ROAD NW
SHALLOTE, NORTH CAROLINA


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DRAWING TITLE
BLDG. SECTIONS

SHEET 8 OF 12



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PLOT DATE
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LOUVERED ALUM. SUNSHADE SHOWN BY LAWRENCEFABRIC.COM (MODEL LFS-FLV) OR APPROVED EQUAL CANOPY MANF. TO PROVIDE SPECIFIC ATTACHMENT DETAILS

NOTES
FOR FOUNDATION AND FRAMING INFORMATION-SEE STRUCTURAL
FOR FINISH INFORMATION SEE FINISH SCHEDULE

5 WALL SECTION
SCALE: 3/4" = 1'-0"

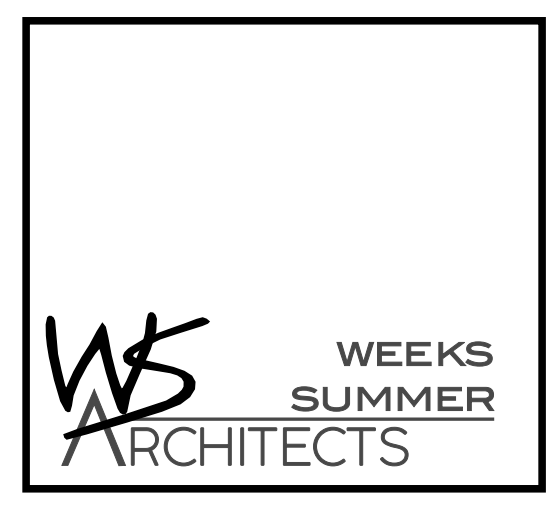4 WALL SECTION
SCALE: 3/4" = 1'-0"

3 WALL SECTION
SCALE: 3/4" = 1'-0"

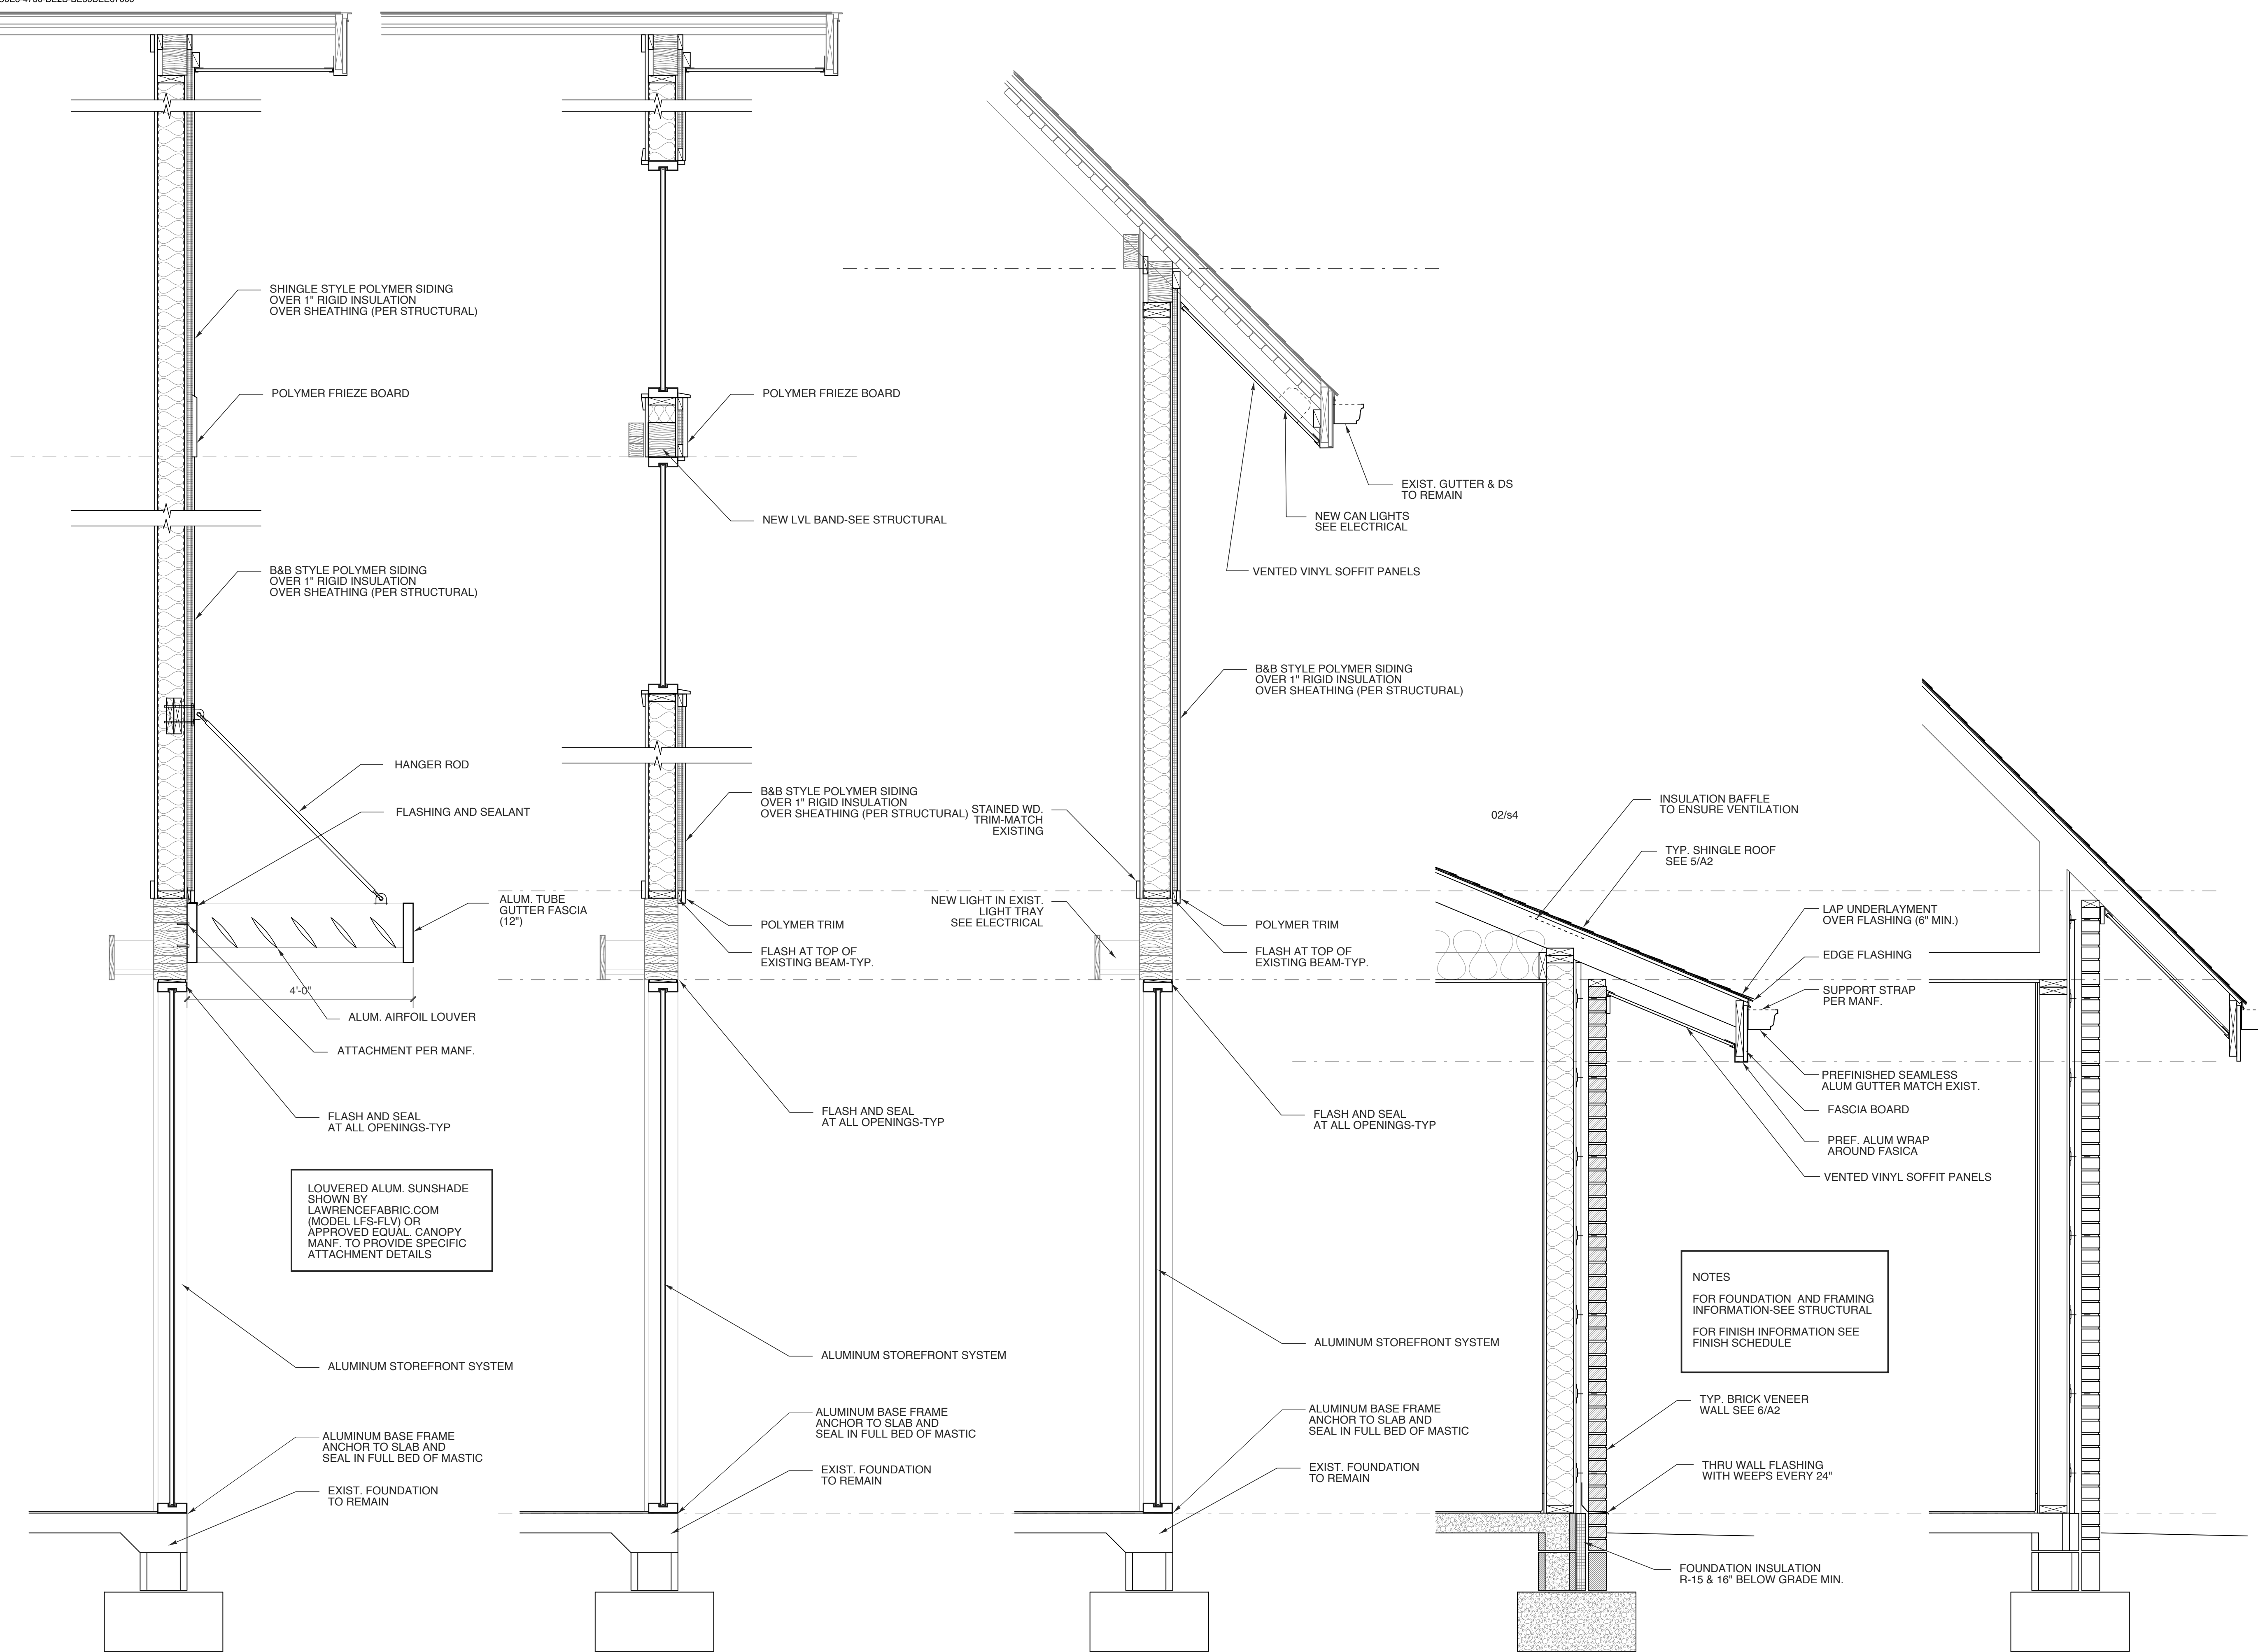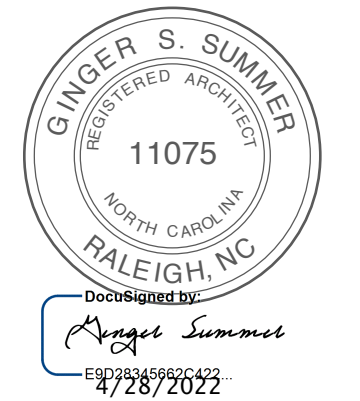2 NEW WALL SECTION
SCALE: 3/4" = 1'-0"

1 EXIST. WALL SECTION
SCALE: 3/4" = 1'-0"

BID SET 4.28.22
WBS: 15RE.13.3
SCO ID# 21-24079-01A

PROJECT TITLE
BRUNSWICK CTY VISTOR'S CENTER
394 WHITEVILLE ROAD NW
SHALLOTE, NORTH CAROLINA


PROJECT NO.
2104a
DRAWING TITLE
WALL SECTIONS

SHEET 9 OF 12



A3.1

PLOT DATE 4/28/22
REVISION 00/00/14

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NOTES
FOR FOUNDATION AND FRAMING
INFORMATION-SEE STRUCTURAL
FOR FINISH INFORMATION SEE
FINISH SCHEDULE
EXIST. INSUL. NOT SHOWN FOR
CLARITY

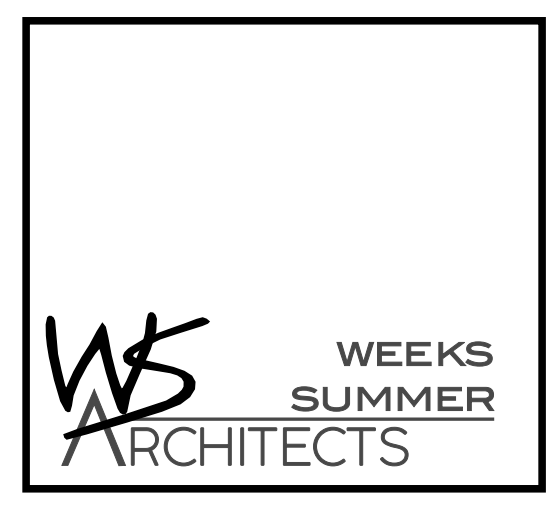2 NEW WALL SECTION
SCALE: 3/4" = 1'-0"

1 NEW WALL SECTION
SCALE: 3/4" = 1'-0"

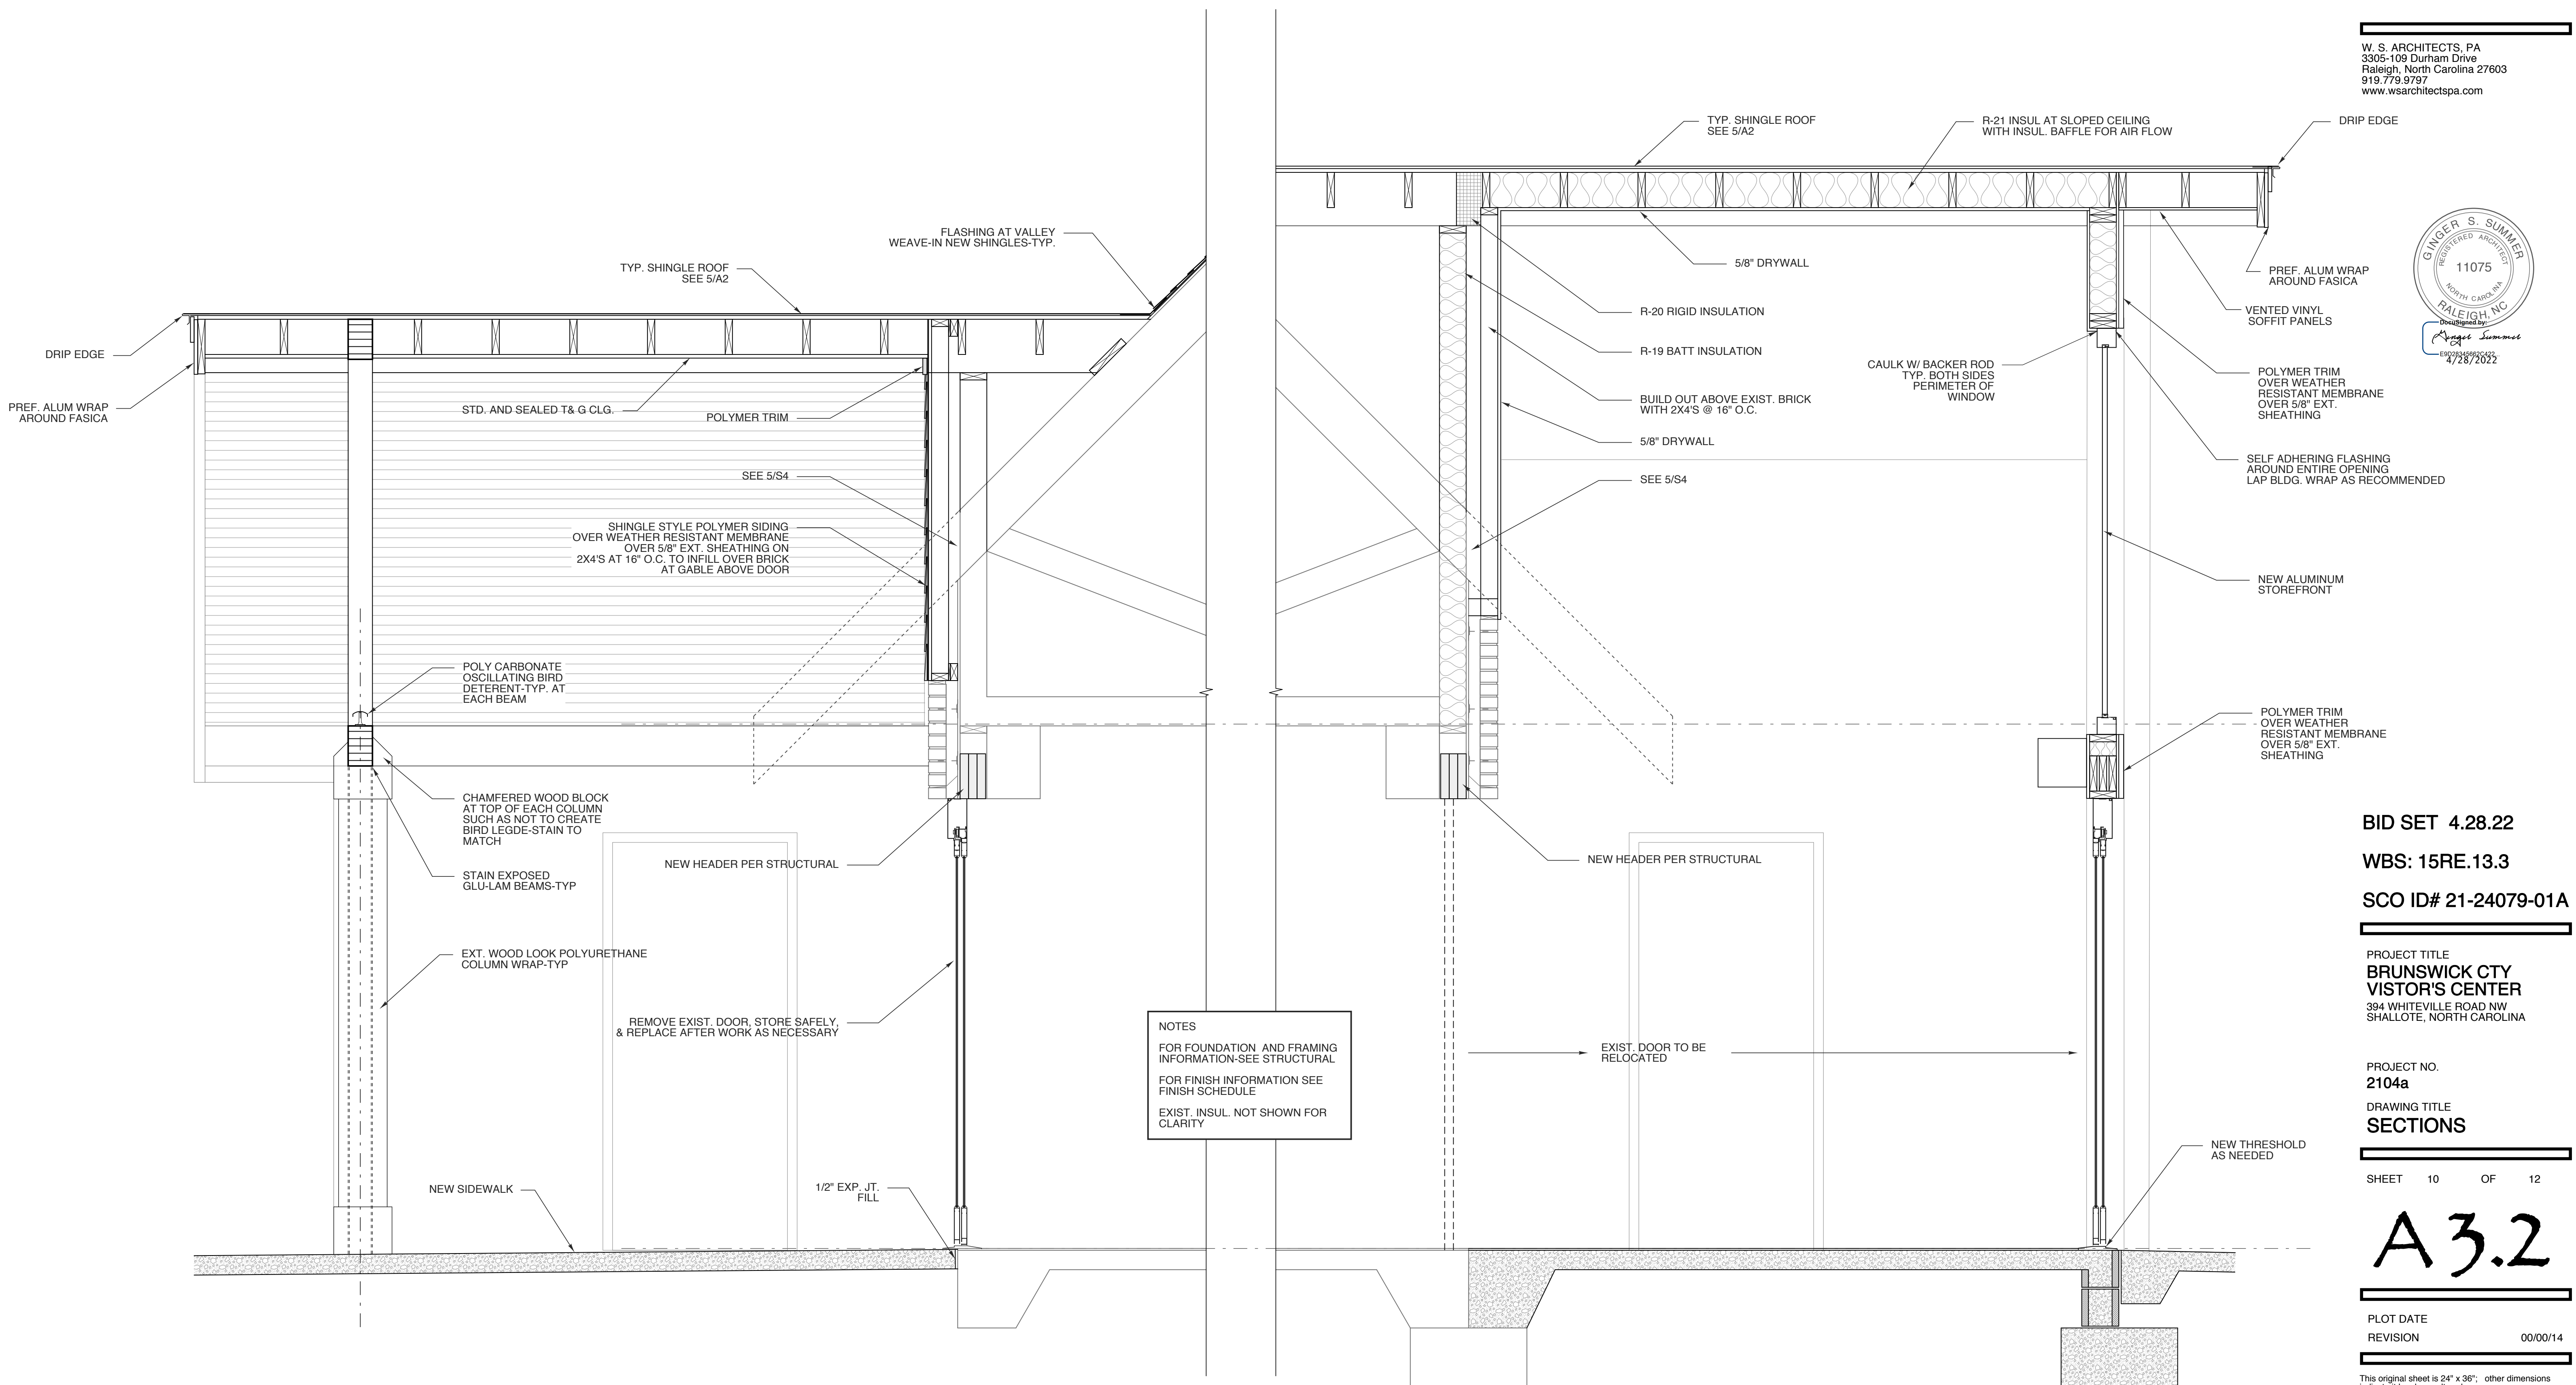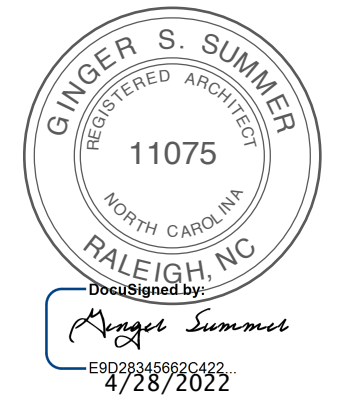BID SET 4.28.22
WBS: 15RE.13.3
SCO ID# 21-24079-01A

PROJECT TITLE
**BRUNSWICK CTY
VISTOR'S CENTER**
394 WHITEVILLE ROAD NW
SHALLOTE, NORTH CAROLINA


PROJECT NO.
2104a
DRAWING TITLE
SECTIONS

SHEET 10 OF 12

A3.2

PLOT DATE
REVISION 00/00/14

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6 ALUMINUM WINDOW
SCALE: 1 1/2" = 1'-0"

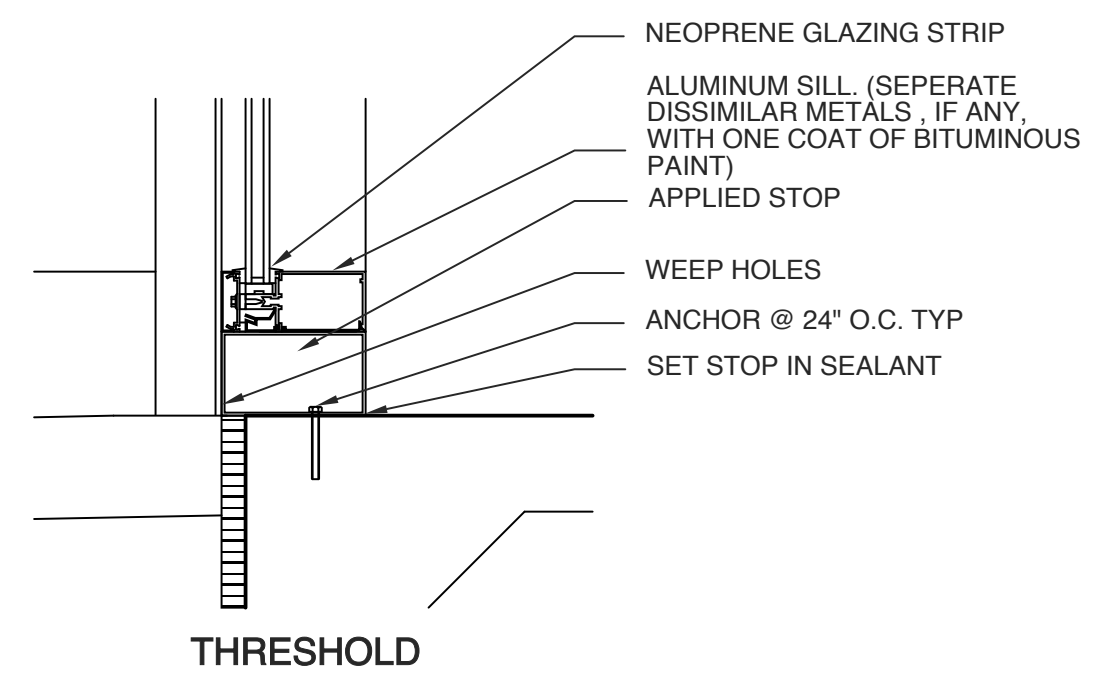
WINDOW SCHEDULE						
MARK	W	SIZE	H	MATERIAL	GLASS	REMARKS
(A)	8'-11"	x	9'-0"	ALUM STOREFRONT	1" INSUL.	---
(B)	10'-8"	x	9'-0"	ALUM STOREFRONT	1" INSUL.	---
(C)	17'-0"	x	9'-0"	ALUM STOREFRONT	1" INSUL.	---
(D)	10'-11"	x	9'-0"	ALUM STOREFRONT	1" INSUL.	---
(E)	10'-11"	x	9'-0"	ALUM STOREFRONT	1" INSUL.	---
(F)	4'-0"	x	6'-0"	ALUM STOREFRONT	1" INSUL.	---
(G)	4'-0"	x	2'-4"	ALUM STOREFRONT	1" INSUL.	OBSCURE GLASS
(H)	4'-0"	x	4'-0"	ALUM STOREFRONT	1" INSUL.	---
(J)	3'-8"	x	6'-8"	ALUM STOREFRONT	1" INSUL.	45 DEG. ANGLE TOP
(K)	3'-8"	x	6'-8"	ALUM STOREFRONT	1" INSUL.	45 DEG. ANGLE TOP

NOTES:
STOREFRONT BASIS OF DESIGN KAWNEER TRIFAB 601T. FINISH TO MATCH EXISTING.
SEE ENERGY REPORT ON COVER SHEET FOR REQUIRED THERMAL VALUES.
ALL FRAME DIMENSIONS TO BE FIELD VERIFIED.
ALL WINDOWS TO MEET NCSBC SECTION 1609.1.2


DOOR SCHEDULE							
MARK	DOOR			FRAME			
	SIZE	MAT'L	TYPE	MAT'L	TYPE	HWDR SET NO.	
(1)	2-3'-0" x 7'-0" x 1-3/4"	ALUM	A	ALUM	---	1	TRANSOM ABOVE
(2)	3'-0" x 7'-0" x 1-3/4"	SC WOOD	B	HM-WLD	---	2	---
(3)	exist. w/ 32" min. clr.	---	---	---	---	---	RELOCATED
(4)	exist. w/ 32" min. clr.	---	---	---	---	---	---
(5)	exist. w/ 32" min. clr.	---	---	---	---	---	---
(6)	exist. w/ 32" min. clr.	---	---	---	---	---	---

NOTES:
- COORDINATE KEYING OF HARDWARE WITH OWNER
- DOOR HANDLES TO BE LEVER HANDLE
- ALL DOORS TO MEET NCSBC SECTION 1609.1.2
- PUSH/PULL HARWARE & KICK PLATE FINISHES TO MATCH HANDLESETS
- STOREFRONT BASIS OF DESIGN KAWNEER TRIFAB 601T. FINISH TO MATCH EXISTING.
- SEE ENERGY REPORT ON COVER SHEET FOR REQUIRED THERMAL VALUES.


HARDWARE SETS
1. PUSH / PULL HARDWARE, THUMBTURN LOCKSET, CLOSER
2. PASSAGE
SEE SPEC

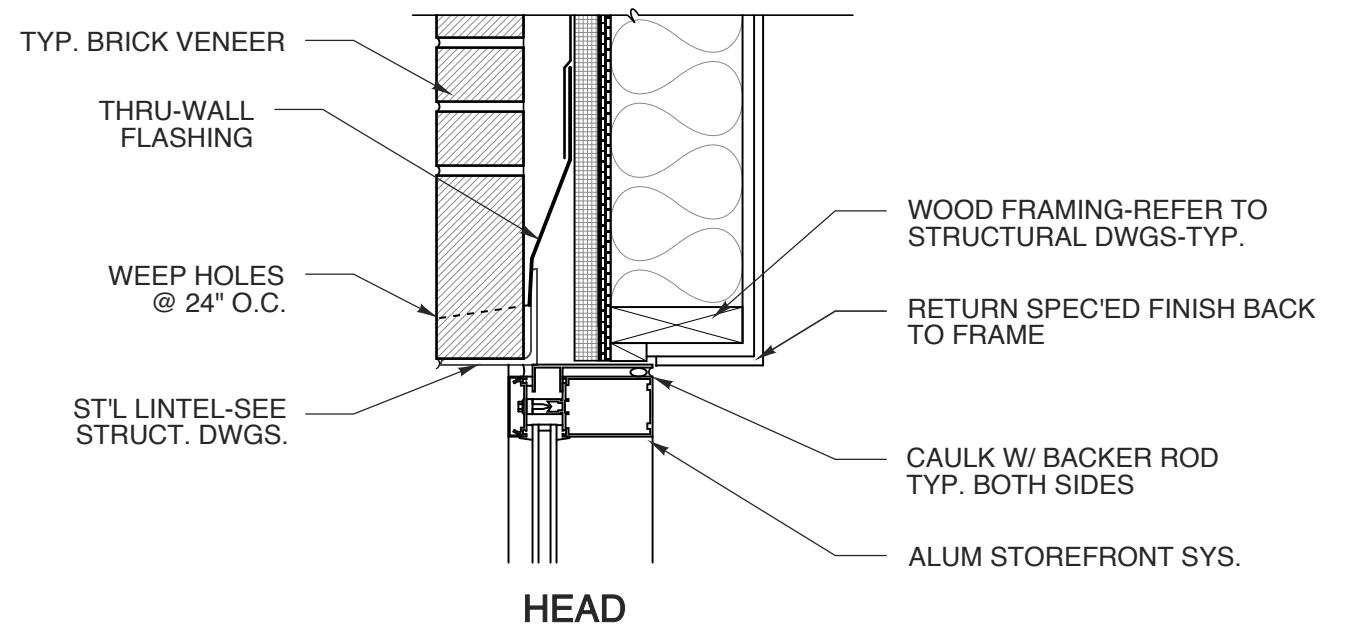

HEAD

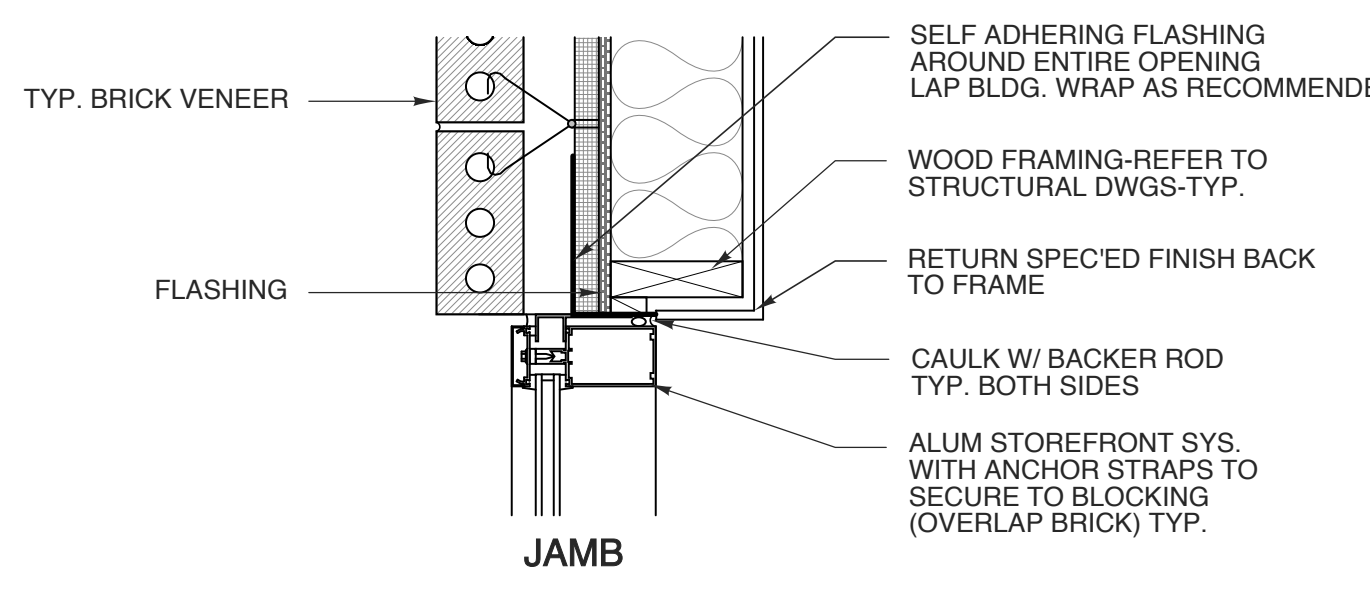


JAMB

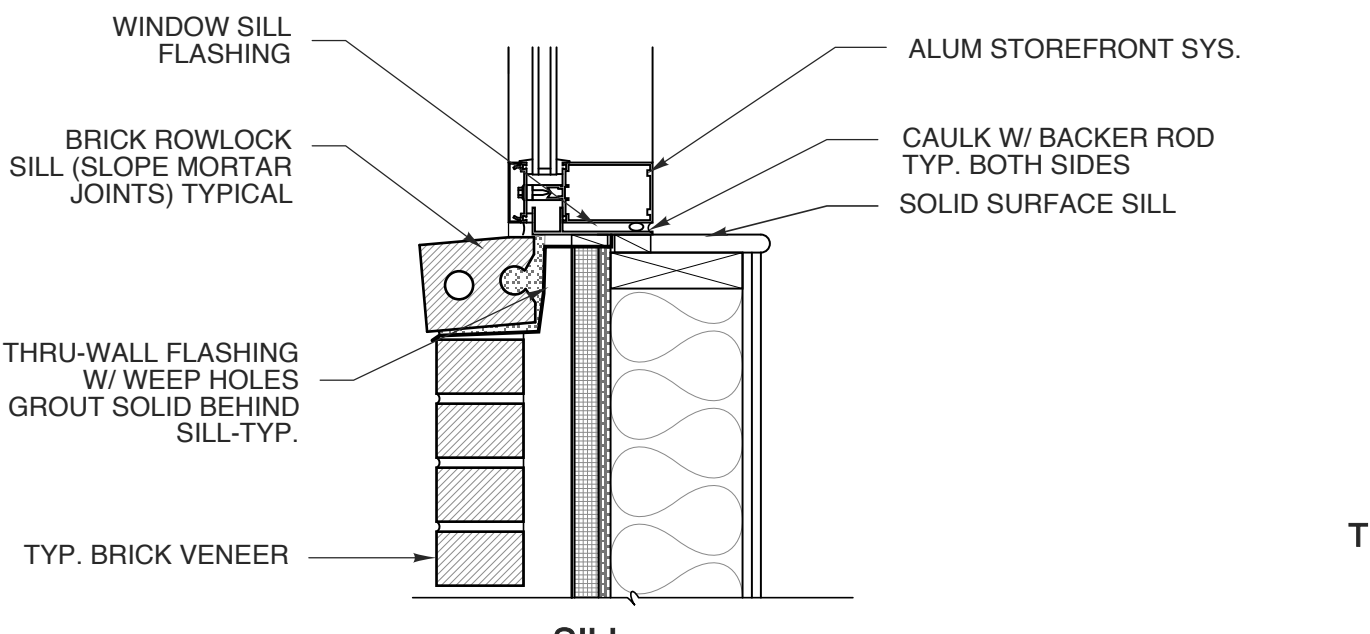


SILL


7 ALUMINUM WINDOWS @ brick
SCALE: 1 1/2" = 1'-0"

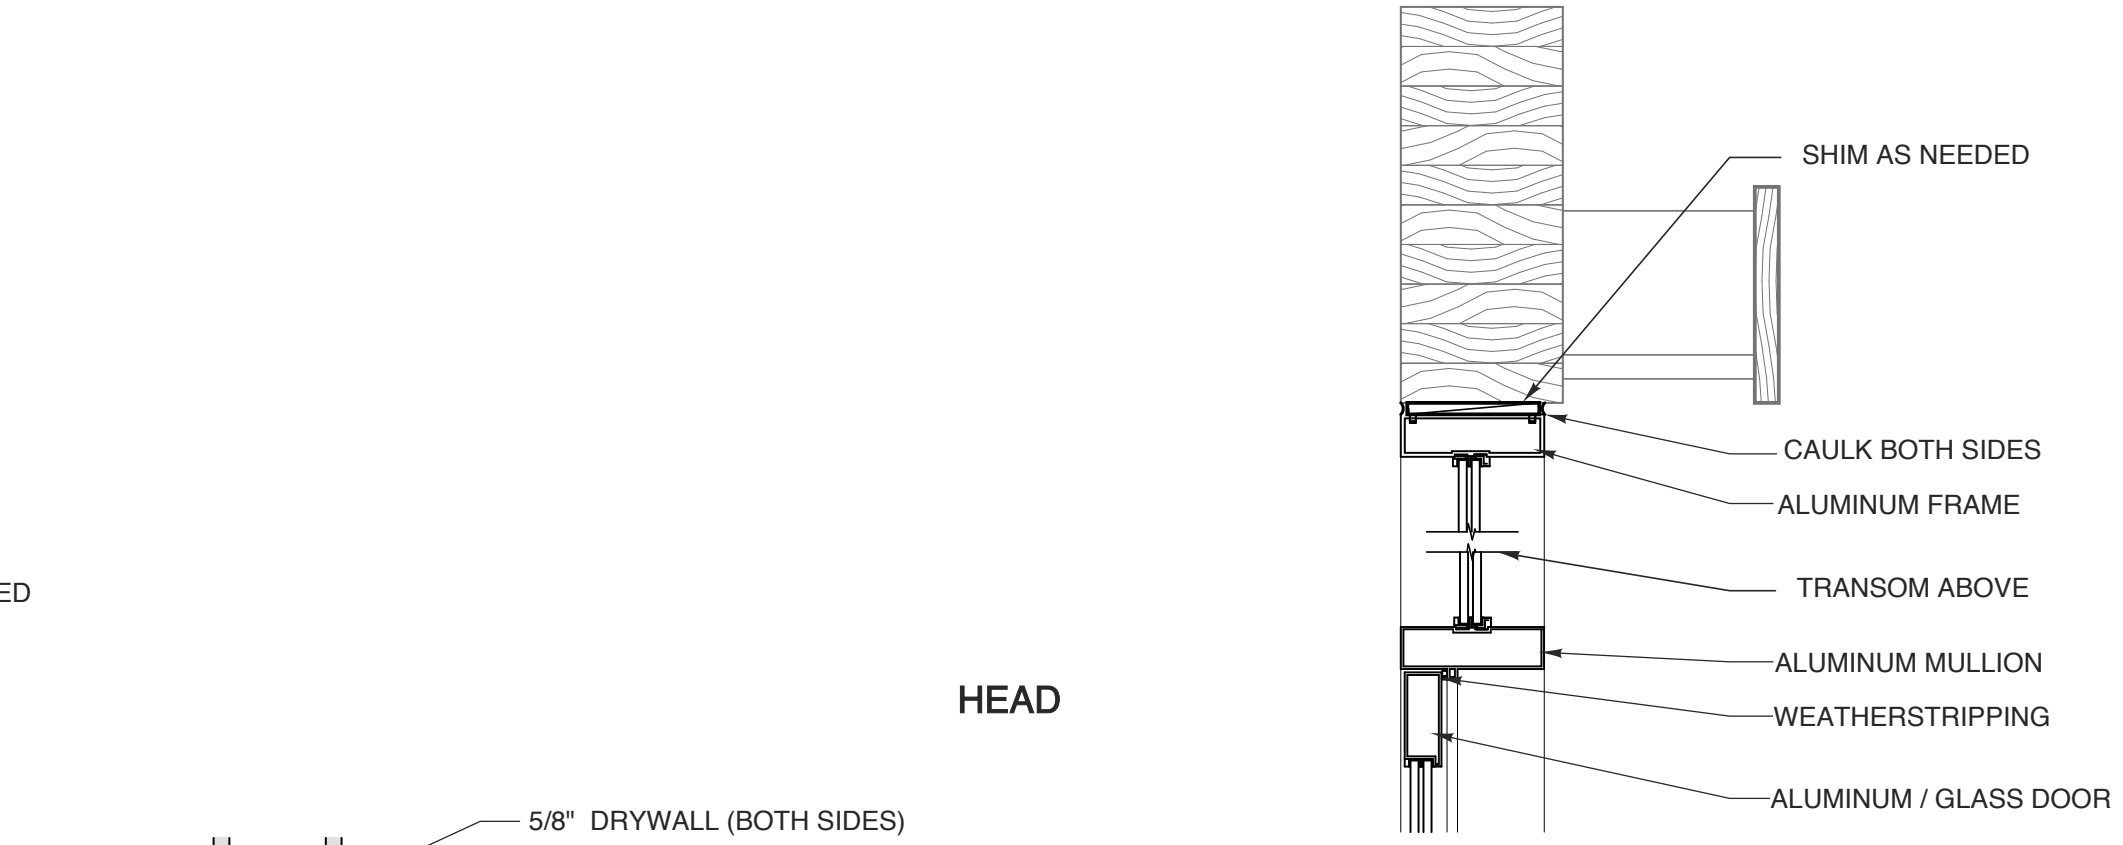

HEAD

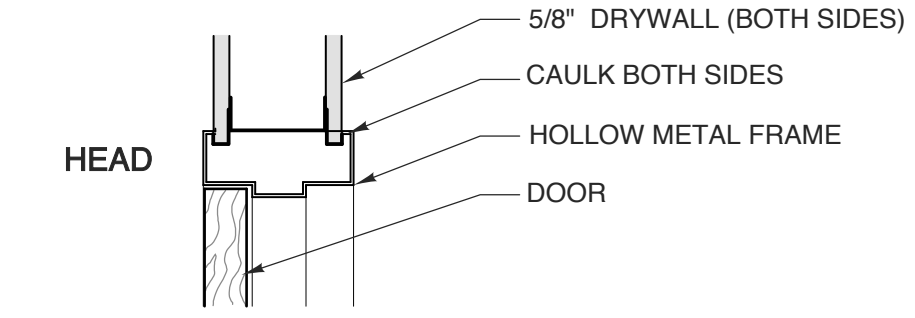


JAMB

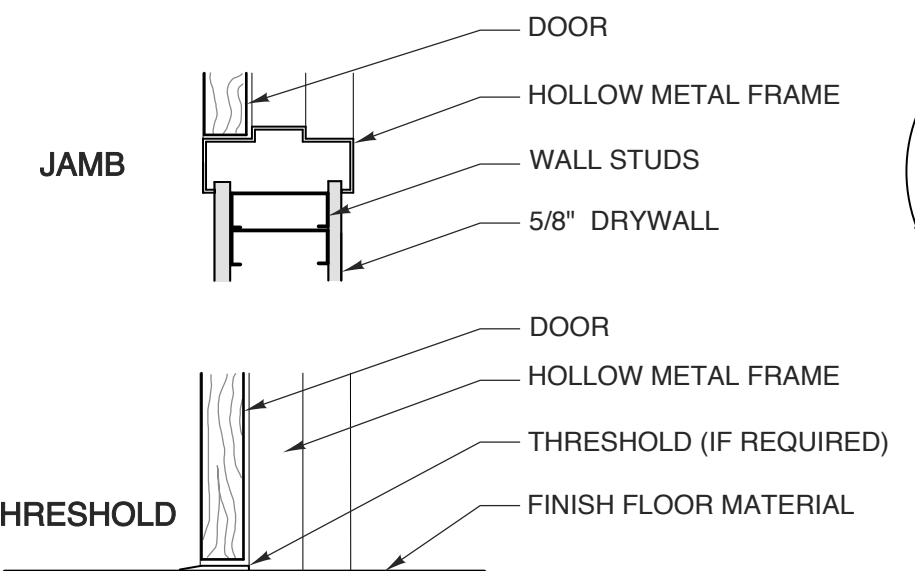


THRESHOLD

5 INT. SOLID WOOD DOOR
SCALE: 1 1/2" = 1'-0"


4 STOREFRONT DOOR W/ TRANSOM
SCALE: 1 1/2" = 1'-0"

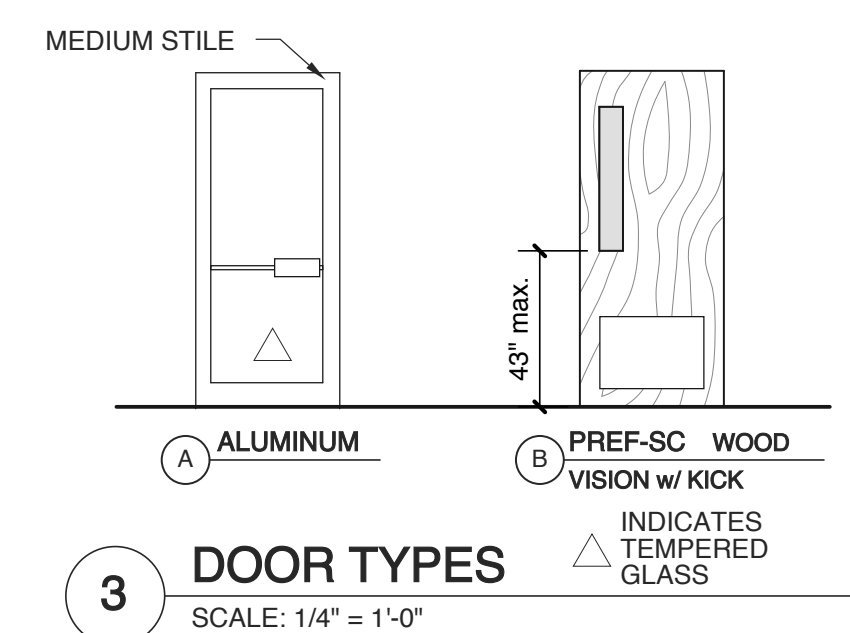

3 DOOR TYPES
SCALE: 1/4" = 1'-0"

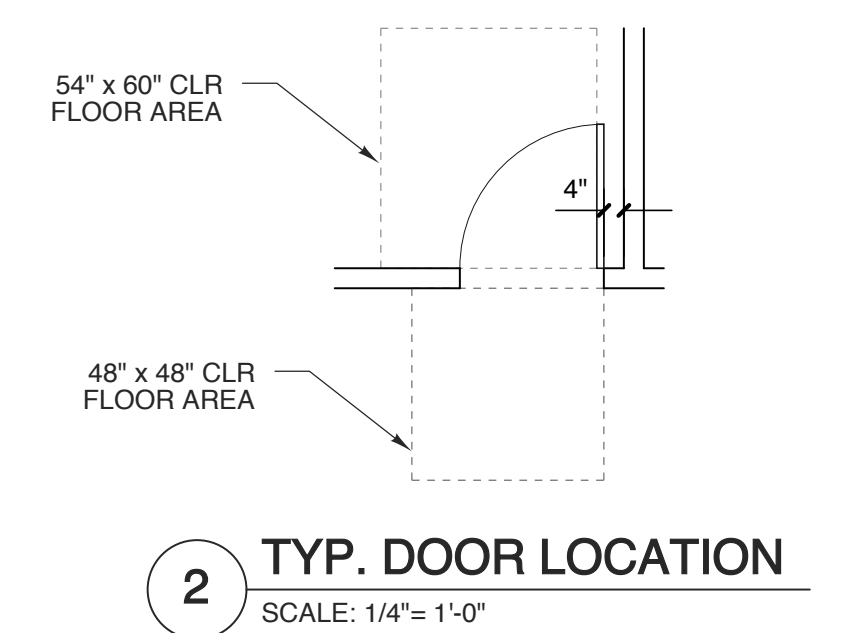


2 TYP. DOOR LOCATION
SCALE: 1/4" = 1'-0"

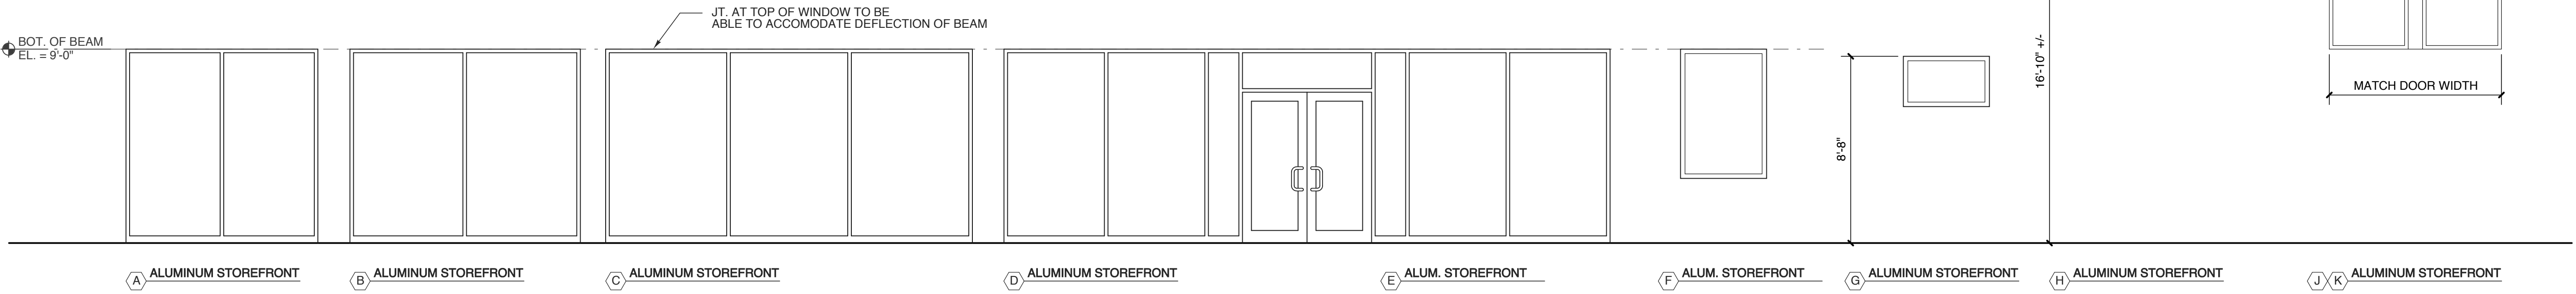


1 DOOR FRAME TYPES
SCALE: 1/4" = 1'-0"

ALL GLASS TO BE TEMPERED PER NCBC SECTION 2406.4

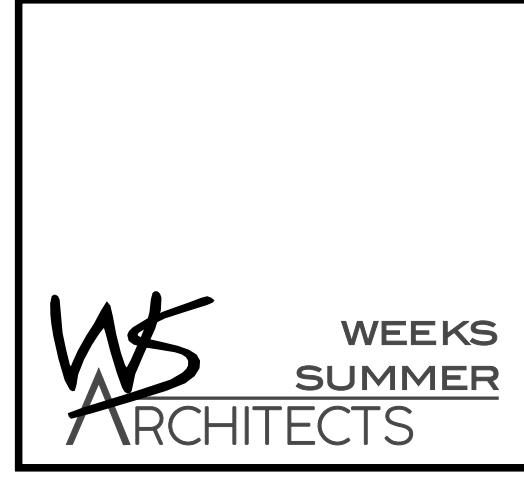

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SCO ID# 21-24079-01A

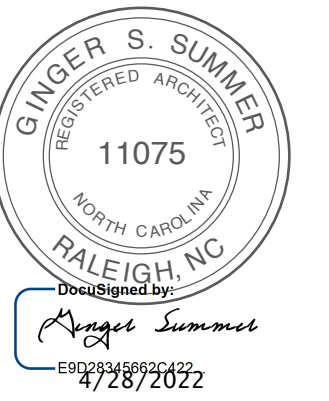PROJECT TITLE
BRUNSWICK CTY VISTOR'S CENTER
394 WHITEVILLE ROAD NW
SHALLOTE, NORTH CAROLINA

PROJECT NO.
2104a
DRAWING TITLE
DOOR & WINDOW SCHED/DETAILS

SHEET 11 OF 12













A4

PLOT DATE 4/28/22
REVISION 00/00/00


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TOILET ACCESSORY SCHEDULE					
MARK	ITEM	MOUNT	MARK	ITEM	MOUNT
A	SURFACE-MOUNTED MULTI-ROLL TOILET TISSUE DISPENSER (B-2892)	28" MIN. 48" MAX. A.F.S.	G	not used	---
B	AUTOMATIC HANDS FREE LIQUID SOAP DISPENSER (AJW U135 EA)	42" MAX. A.F.S.	H	RECESSED PAPER TOWEL DISP. AND WASTE RECEPTACLE (B-43944)	RE: ELEV.
C	36" HORIZONTAL GRAB BAR (B-6806.99 X 36)	33"-36" A.F.S.	J	WELDED FRAME MIRROR (B-2908-1830)	RE: ELEV.
D	42" HORIZONTAL GRAB BAR (B-6806.99 X 42)	33"-36" A.F.S.	K	WELDED FRAME MIRROR (B-2908-1860)	RE: ELEV.
E	18" VERTICAL GRAB BAR (B-6806.99 X 18)	RE: ELEV.	L	not used	---
F	SHELF W/ MOP & BROOM HOLDERS & RAG HOOKS (B-224 X 36)	48" A.F.S.	M	not used	---

MANUFACTURER: BOBRICK WASHROOM EQUIPMENT U.N.O. OR APPROVED EQUAL-SEE SPECIFICATION FINISH: SATIN STAINLESS STEEL
NOTE: GC TO INSTALL BLOCKING FOR ALL TOILET ACCESSORIES AND TOILET PARTITIONS AS REQ'D

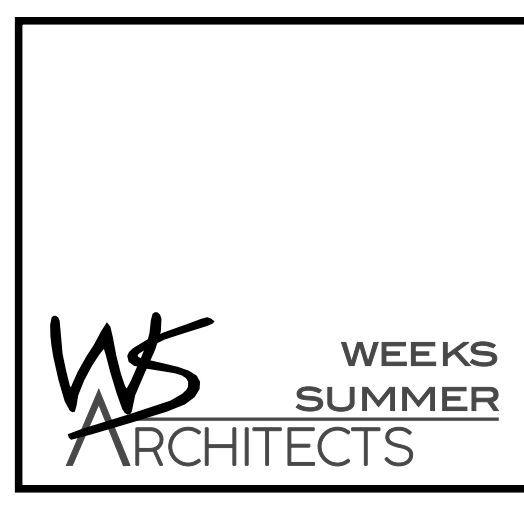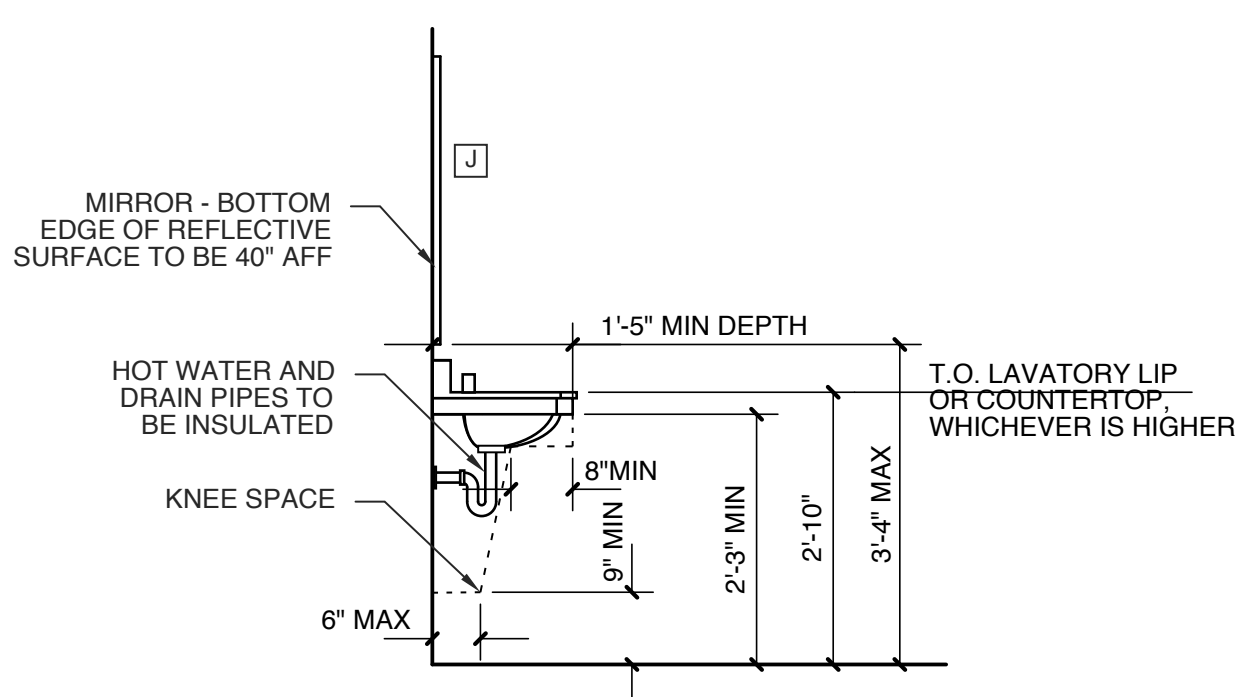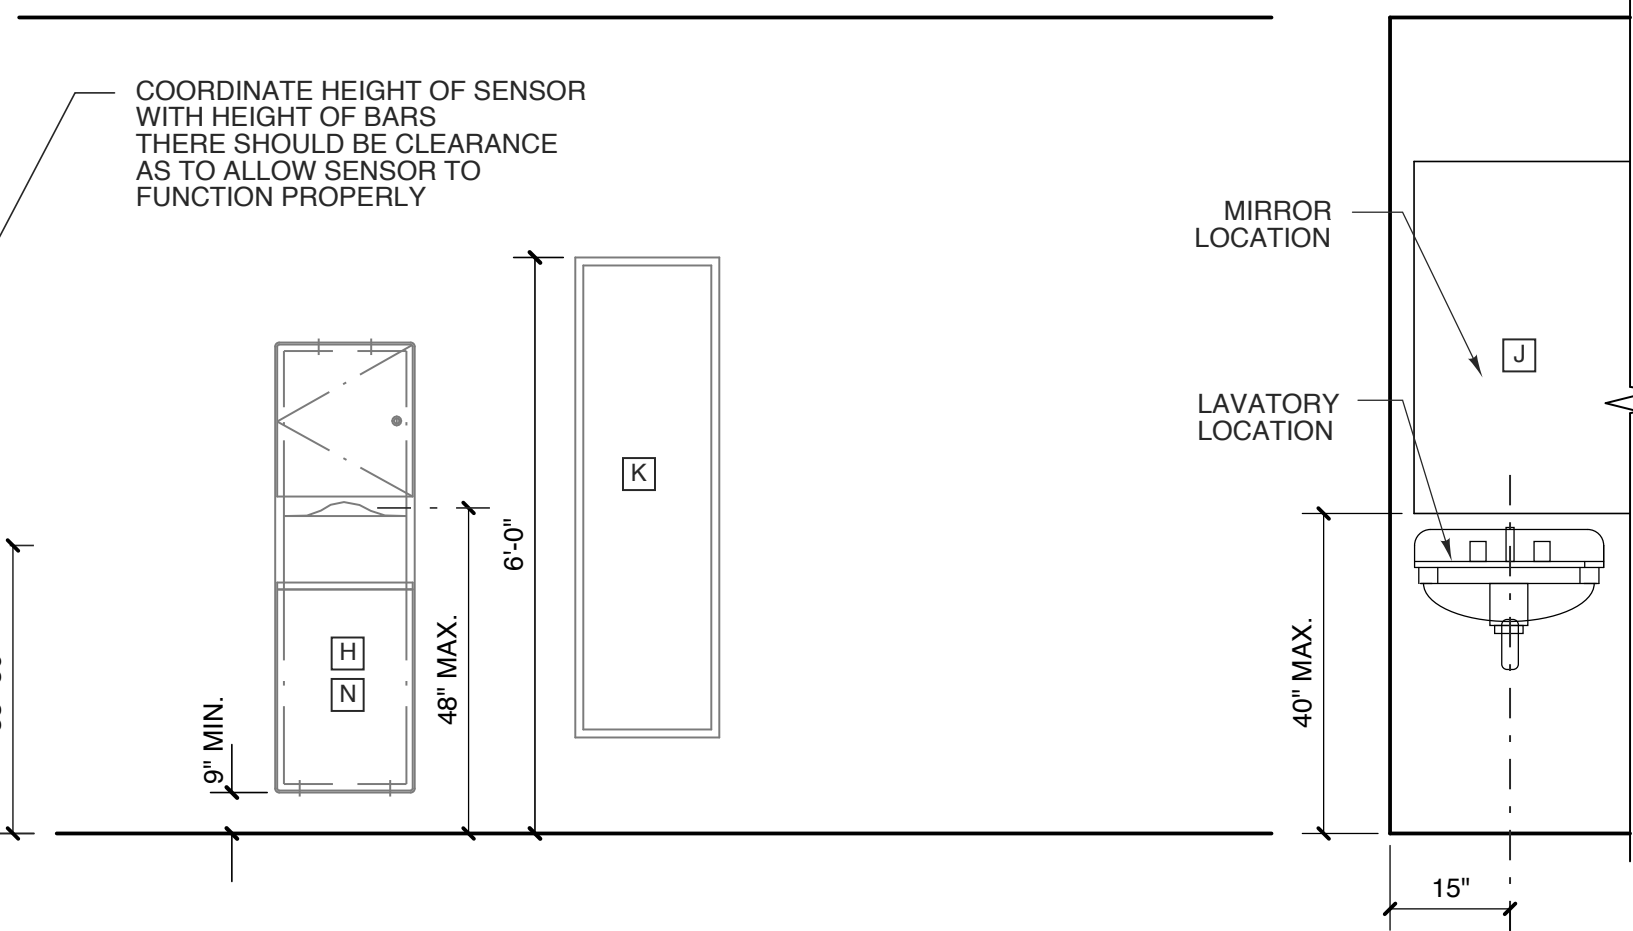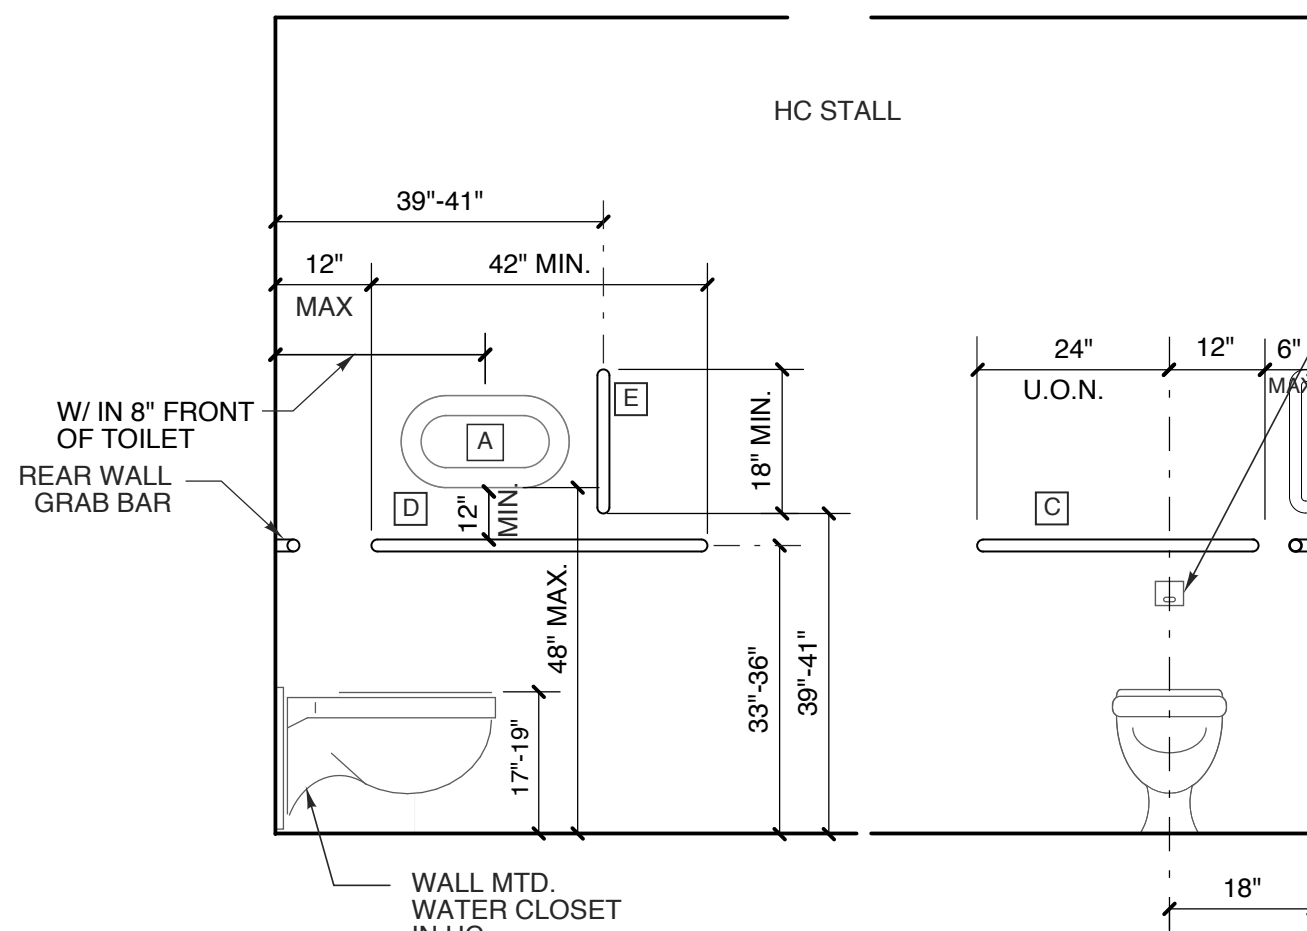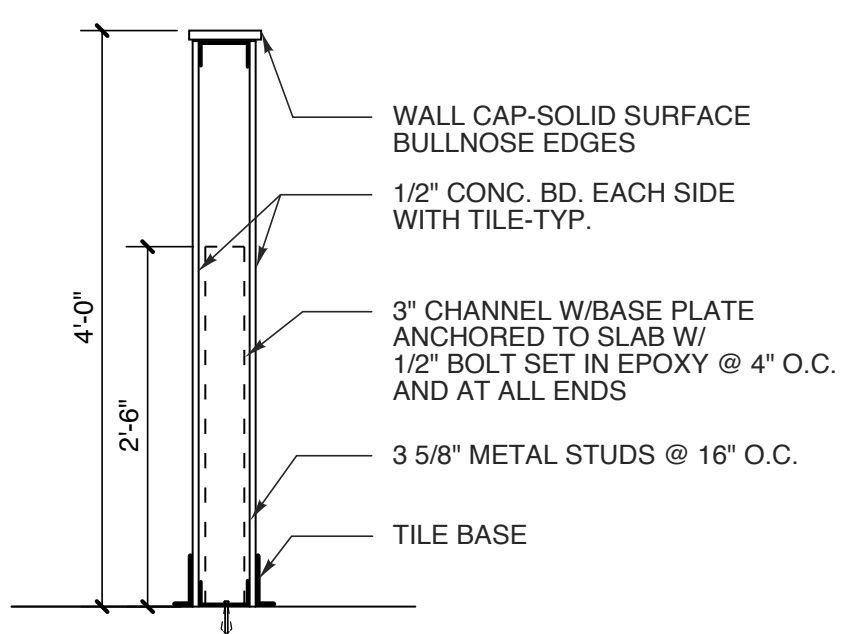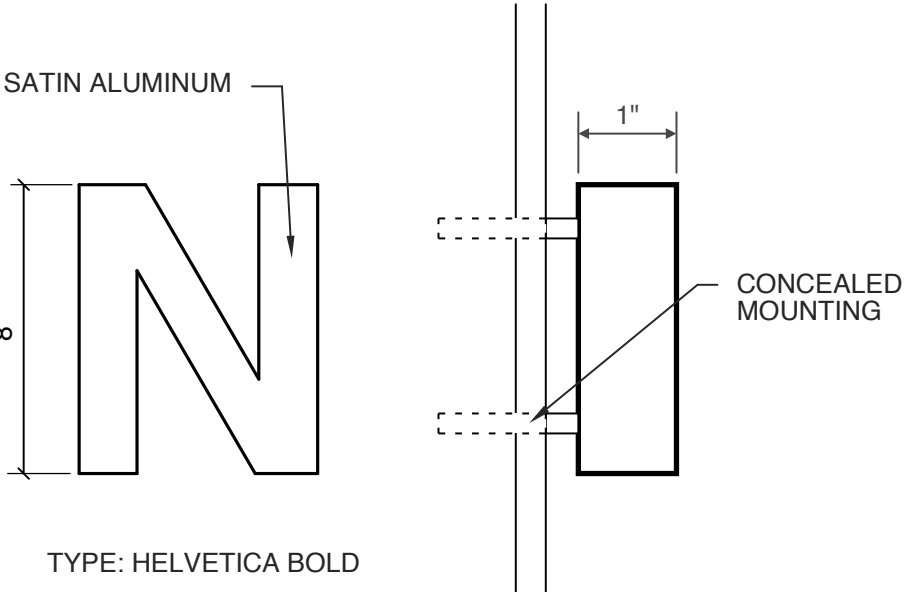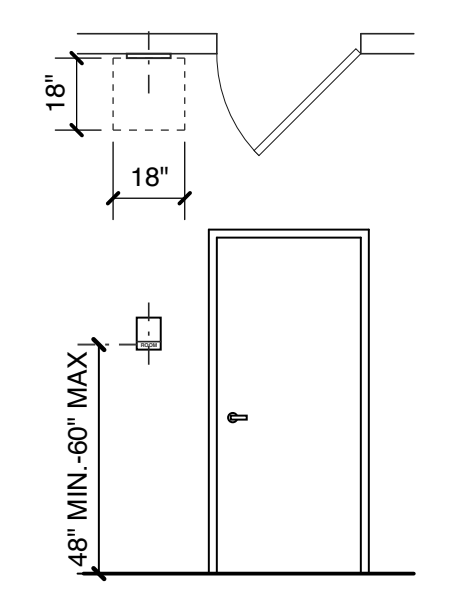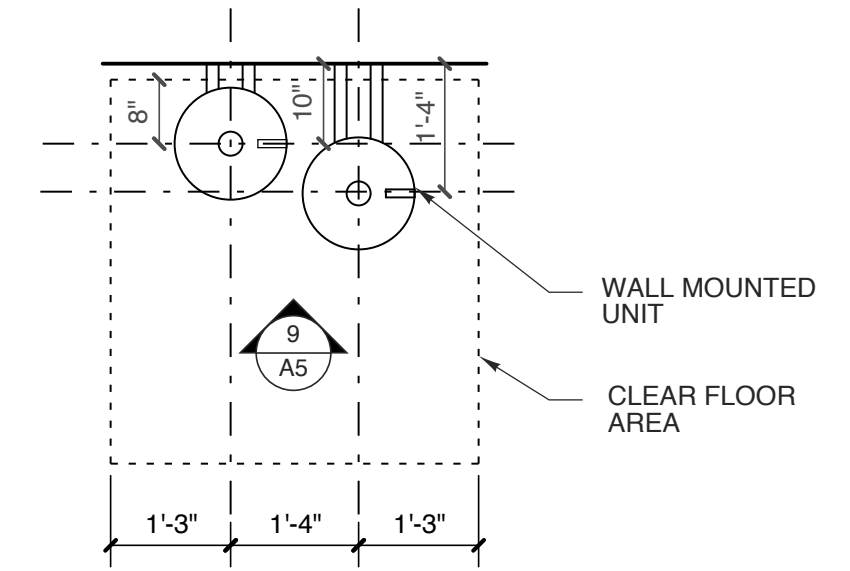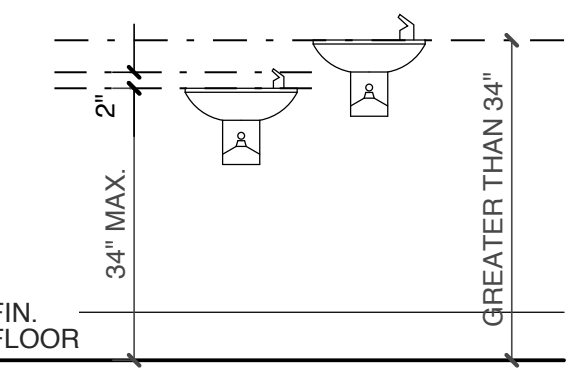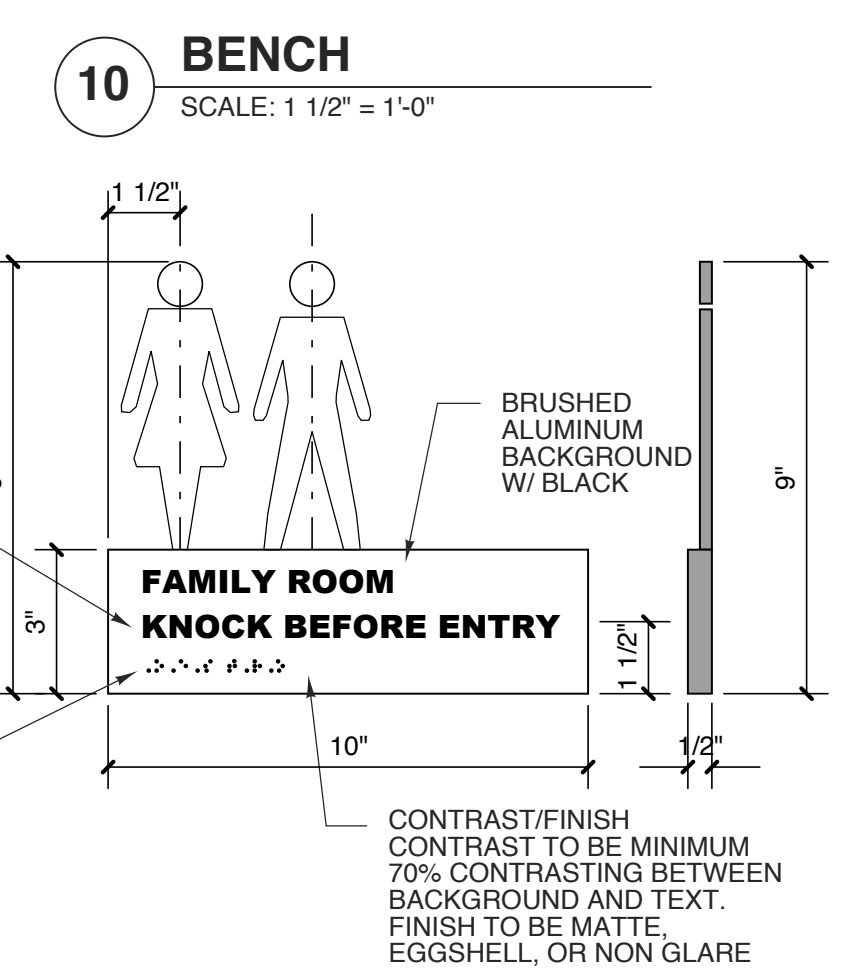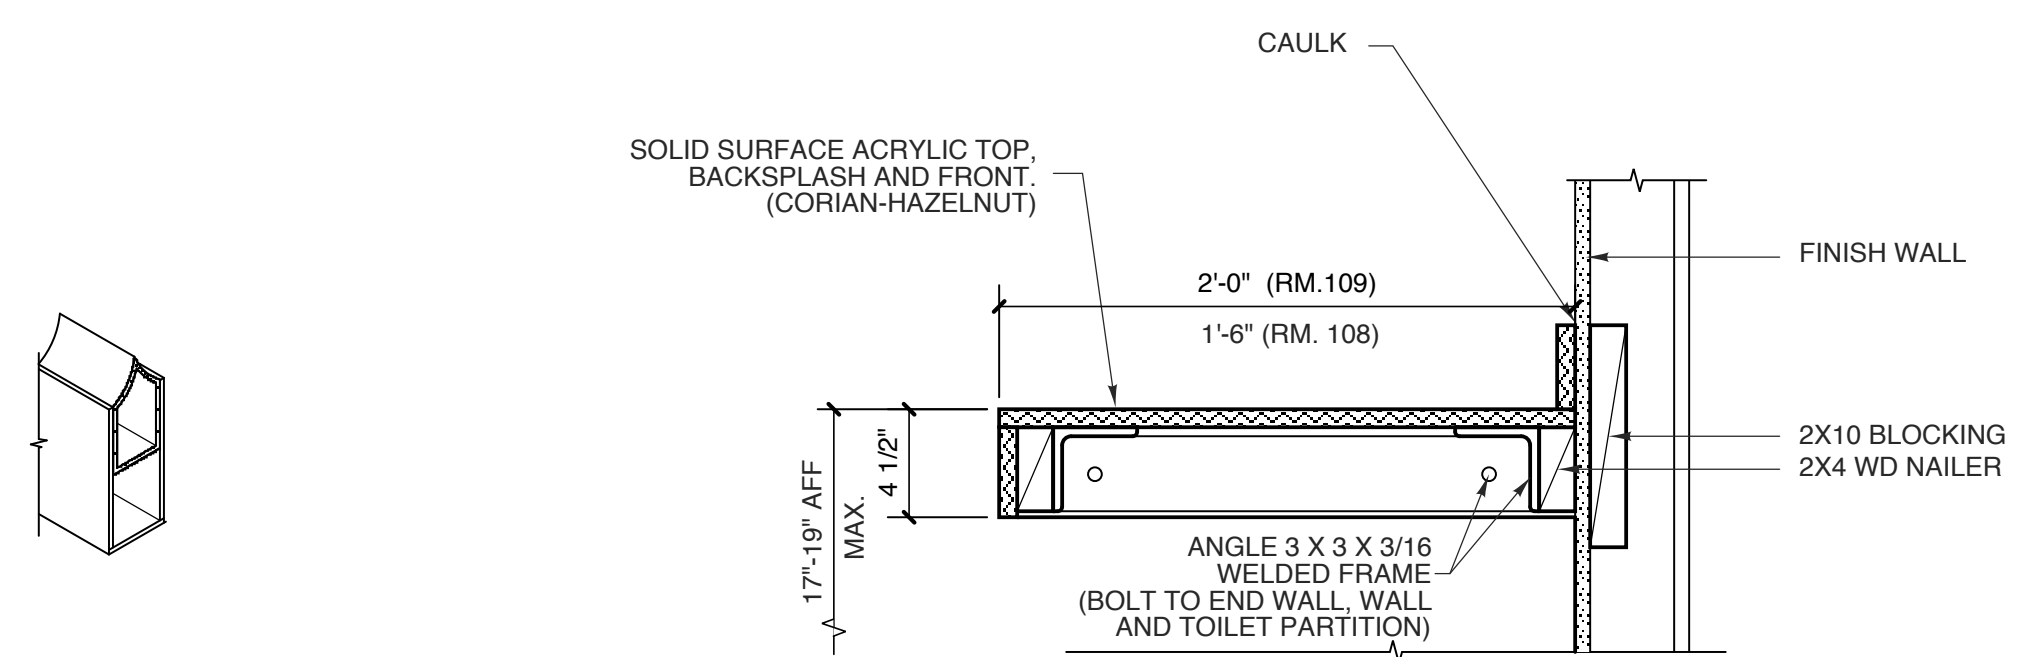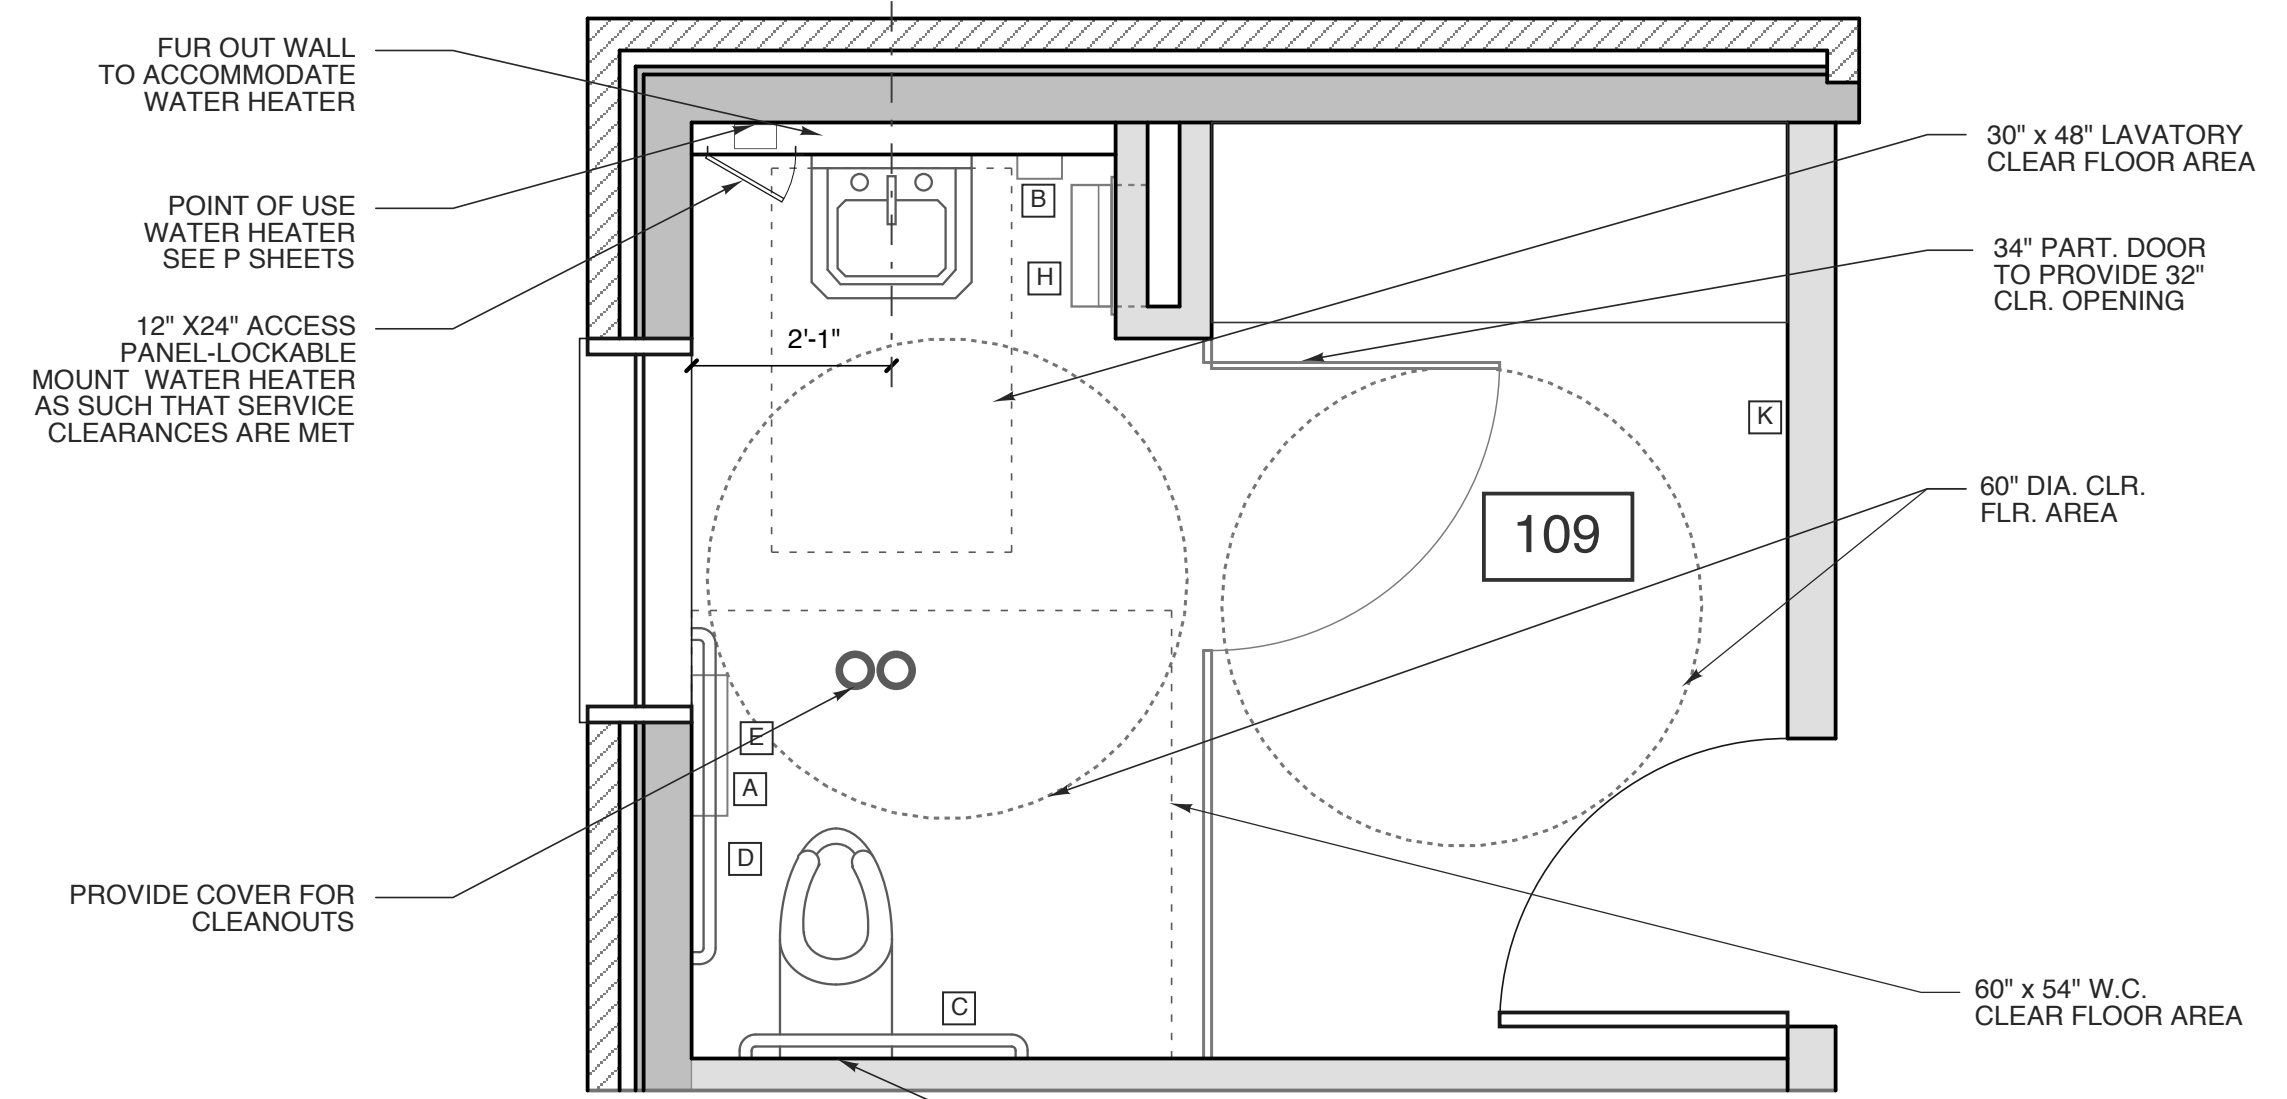

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BID SET 4.28.22
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SCO ID# 21-24079-01A

PROJECT TITLE
BRUNSWICK CTY VISTOR'S CENTER
394 WHITEVILLE ROAD NW
SHALLOTE, NORTH CAROLINA

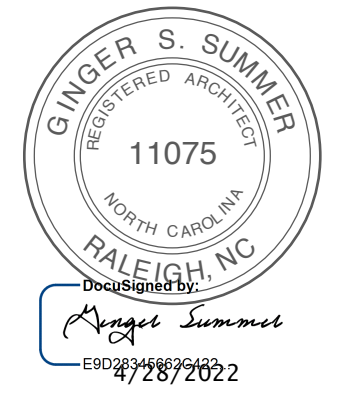PROJECT NO.
2104a
DRAWING TITLE
DETAILS

SHEET 12 OF 12

A5

PLOT DATE 4/28/22
REVISION 00/00/00

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